

Title **Plum Grove Park Facility 4001**

Park Drive, Palatine IL 60067

02/24/2023

id. 35659131

by tim k in Member District ADA Project Request

3000 Central Road Rolling Meadows, Illinois 60008 **United States** 8478183223 TKlier@rmparks.org

Dominic Calderisi

02/24/2023

Original Submission

Name

Job Title	Safety Coordinator / Project Manager
E-mail Address	dcalderisi@rmparks.org
Phone Number	18473444877
Park District	Rolling Meadows
Project Location	Plum Grove Park Facility 4001 Park Drive, Palatine IL 60067
Project Status	New
Project Type	Routes and Surfaces
Routes and Surfaces- select a Project Category below:	Accessible Routes- Means of Egress Curb Ramps Sidewalks Walking Surfaces
Benefits of the Project	Rolling Meadows Park District's Plum Grove Park Outdoor Pool Facility was replaced with an ADA accessible courtyard featuring a new ADA compliant sidewalk that winds its way throughout a beautifully sculped lawn with various flower and rain gardens. The sidewalks also lead to several ADA accessible resting areas with park benches. The sidewalk path gives greater access to the Plum Grove building in which multiple NWSRA programs take place. A new pavilion has also been added with ADA compliant picnic tables. These improvements allow for greater accessibility to Plum Grove Park and its amenities, especially for those with disabilities, thereby narrowing the play gap between people of all abilities.
Items that will become ADA Compliant	Sidewalks, Ramps, Accessibility to Park Amenities, Park Benches, Picinic Tables

The project is designed or constructed, or applies human resources, to comply with:

The 2010 Standards for Accessible Design The Illinois Accessibility Code Agency's ADA Transition Plan

Upload Project Related Files, Photos, Videos or Audio

20190308-Plum_Grove.pdf

AIA_Document_COs_5_and_6_FINAL-Signed.pdf

IMG 2764.JPG

IMG 2765.JPG

IMG 2769.JPG

IMG_2770.JPG

IMG 3853.JPG

IMG 3850.JPG

IMG_3856.JPG

IMG 3857.JPG

IMG 2766.JPG

Budget Table for ADA Related Expenses

Budget Table.xlsx

ADA	Dollars
Requ	ested

102444.36

Notes related to requested amount

This would max us out beyond what we are eligible for, which is roughly \$250,000. If all other submissions from the Rolling Meadows Park District have been accepted for the full amount requested, the total, excluding this project, would be \$177,450.82. This would leave us with a remaining balance of \$72,549.18. Even though we are requesting the standard 33% for this sort of project, we realize that we would only receive the equivalent of the remaining balance.



225 W. Jefferson Avenue Naperville, IL 60540 T 630.961.1787 hitchcock**design**group.com

Plum Grove Park

4001 Park Drive Palatine, Illinois 60067

Rolling Meadows Park District 3000 Central Road, Suite 100 Rolling Meadows, Illinois 60008

Issue for Construction March 8, 2019

Project Team

Landscape Architect Hitchcock Design Group

Sheets: L-series

225 West Jefferson Avenue Naperville, Illinois 60540 T 630.961.1787

Civil Engineer WT Group LLC, Civil

Engineering Division 2675 Pratum Avenue Hoffman Estates, Illinois 60192 T 224.293.6333

F 224.293.633

T 219.865.3352

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Sheets E-series

Electrical Engineer Nova Engineering PC 2338 Cline Avenue Schererville, Indiana 46375

Sheets C-series

Architect Sheets A-series Robert Juris & Associates Architects, LTD. 9400 Bormet Drive, Suite #6 Mokena, Illinois 60448

General Notes

- 1. Basemap information obtained from plans prepared by W-T Land Surveying received January 9, 2018.
- 2. Verify site conditions and information on drawings. Promptly report any concealed conditions, mistakes, discrepancies or deviations from the information shown in the Contract Documents. The Owner is not responsible for unauthorized changes or extra work required to correct unreported discrepancies.
- 3. Secure and pay for permits, fees and inspections necessary for the proper execution of this work. Comply with codes applicable to this work.
- 4. Refer to specifications for additional conditions, standards and notes.

Project Location Map



Project Location

It's smart.	It's free.	It's the law.
Call Before You Dig	Call t	efore
	you d	lig.
ILLINOIS ONE-CALL SYSTEM	8.008	B92.0123

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	01100111	Idox
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	L2.0	Layout and Materials Plan
	L3.0	Planting Plan
	L4.0-L4.2	Details
	C-Series	
,	T-1.0	Title Sheet
	C10	Site Demolition Plan

C-Selles	
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C-1.0	Site Demolition Plan
C-2.0	Site Geometric Plan
C-3.0	Site Development Plan
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C-5.0	Site Utility Plan
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E-Series

E1.0 Electrical Site Plan E2.0 Electrical Schedules

A-Series

Site Plan & Details **A**1

EX-Series EX-1.0 Impervious/Previous Area Exhibit


EX2.0 Disturbed Area Exhibit EX-FP Floodplain Exhibit **EX-XSEC** Compensatory Storage Cross Sections

Maintenance and Monitoring Plan

S-Series

EX-M

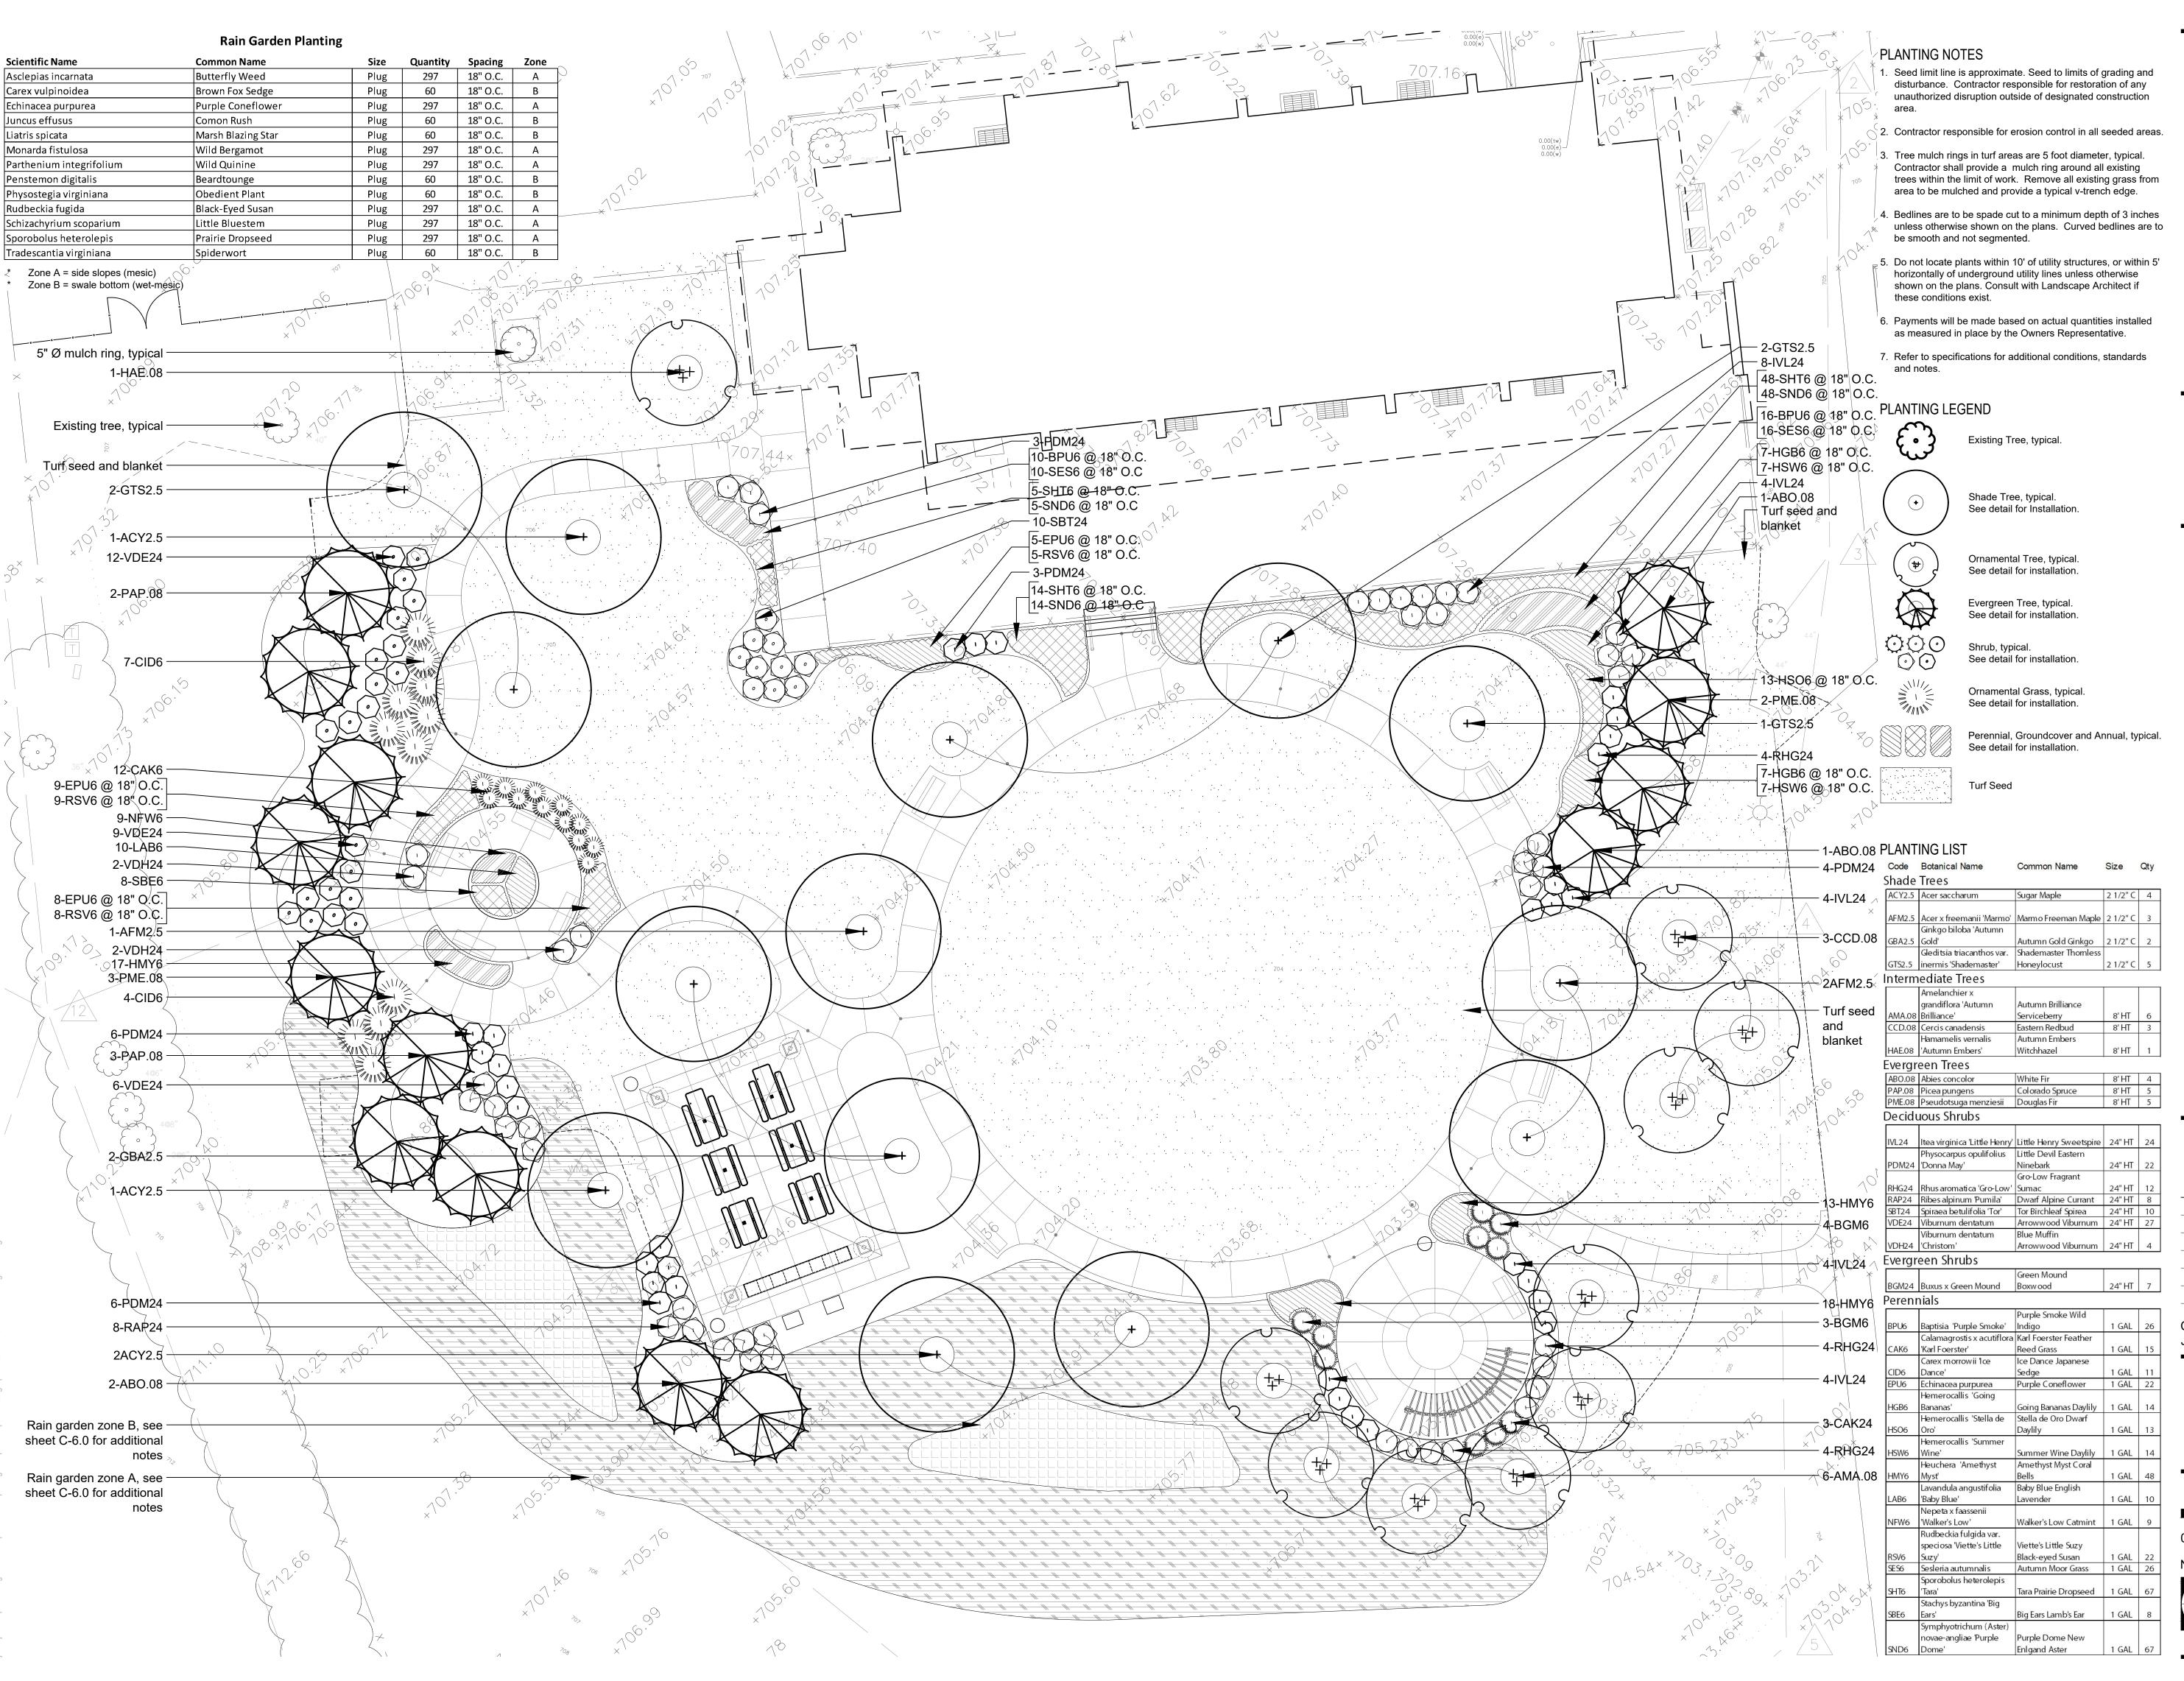S-1 Topographic Survey



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PREPARED FOR

Rolling Meadows Park District

3000 Central Road, Suite 100 Rolling Meadows, IL 60008

PROJECT

Plum Grove Park

4001 Park Drive Palatine, IL 60067

CONSULTANTS

Civil Engineer
WT Group LLC, Civil Engineering
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Architect
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Issued March 8, 2019 REVISIONS

No Date Issue

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SHEET TITLE

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Planting Plan

SCALE IN FEET
1" = 10'
5' 10' 30'
RTH SHEET NUMBER

NORTH

L3.0


PLUM GROVE PARK 4001 PARK DRIVE ROLLING MEADOWS, ILLINOIS 60067

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	S-1	TOPOGRAPHIC SURVEY (PREPARED BY W-T LAND SURVEYING, INC.)	3-26-18	

BENCHMARKS:

BENCHMARK #I - EAST-NORTHESAT UPPER FLANGE BOLT OF FIRE HYDRANT LOCATED ON THE SOUTH SIDE OF THE EAST PARKING LOT ISLAND (AS SHOWN). ELEVATION=706.57' (NAVD88)

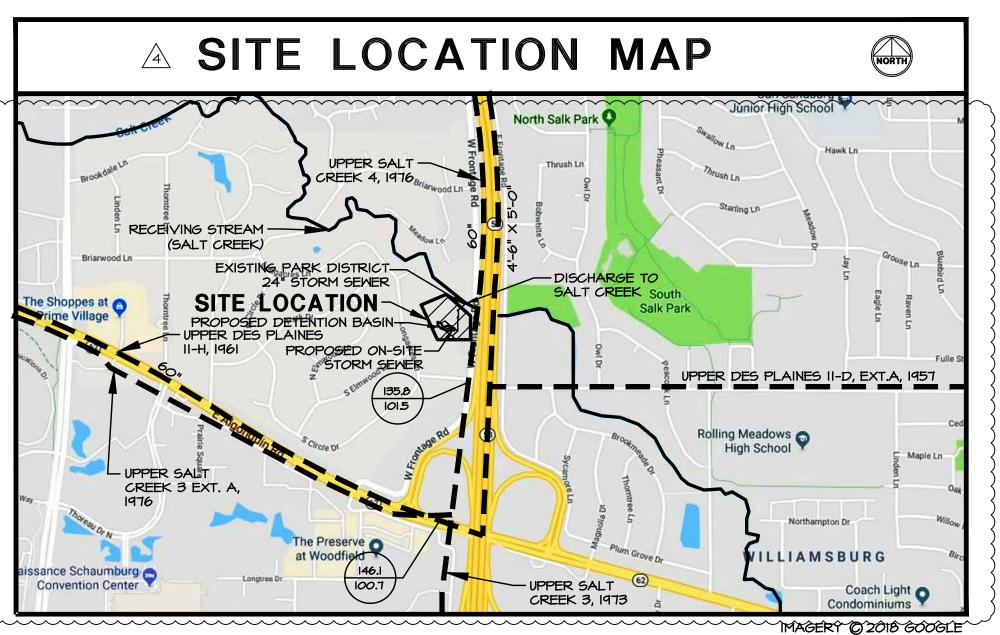BEING THAT THIS PROJECT IS PERMITTED UNDER THE NEW WATERSHED MANAGEMENT ORDINANCE (WMO), THE MWRD REQUIRES 48 HOURS OF ADVANCE NOTIFICATION PRIOR TO ANY GROUND DISTURBANCE. THE MWRD WILL BE INSPECTING FOR APPLICABLE EROSION CONTROL AND SEDIMENT CONTROL MEASURES SUCH AS SILT FENCING, INLET PROTECTION, CONCRETE WASH, ETC., FOLLOWED BY SANITARY SEWER AND VOLUME CONTROL INSTALLATION INSPECTIONS. PLEASE REFER TO THE APPROVED PERMIT/PLANS AND HAVE THESE MEASURES IN PLACE IN ACCORDANCE WITH THE SPECIFICATIONS.



SECTION 35, TOWNSHIP 42 NORTH, RANGE 10 EAST

SCALE - I" = 1000'

LEGEND

STORM SEWER M.W.R.D. SEWERS

GROUND ELEVATION CCD 101.5 SEWER INVERT ELEVATION CCD

CIVIL ENGINEERING STATEMENT AND SEAL

I, TODD ABRAMS, P.E., DULY LICENSED IN THE STATE OF ILLINOIS BY THE DEPARTMENT OF FINANCIAL AND PROFESSIONAL REGULATION, DO HEREBY STATE AND TO THE BEST OF MY KNOWLEDGE AND BELIEF DOES CONFORM TO THE APPLICABLE BUILDING CODES AND ORDINANCES, AND ARE IN COMPLIANCE WITH THE ENVIRONMENTAL BARRIERS ACT [410 ILCS 25] AND THE ILLINOIS ACCESSIBILITY CODE (71 ILL. ADM. CODE 400).

DATE:

TODD ABRAMS - ILLINOIS P.E. # 062-061600 DATE OF EXPIRATION - NOVEMBER 30, 2019

> CALL JULIE SIMPLY 811 OR TOLL FREE 1(800)892-0123 OPERATES 24 HOURS A DAY 365 DAYS A YEAR



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CONTRACTOR MUST LOCATE PRIVATE UTILITIES IN AREA OF CONSTRUCTION PRIOR TO PROCEEDING WITH WORK

Naperville, IL 60540 T 630.961.1787 F 630.961.9925 hitchcock**design**group.com

PREPARED FOR Rolling Meadows Park District

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Plum Grove Park

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Architect Robert Juris & Associates Architects, LTD. 9400 Bormet Drive, Suite #6 T 815.806.0146

March 8, 2019 REVISIONS

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SHEET TITLE Title Sheet

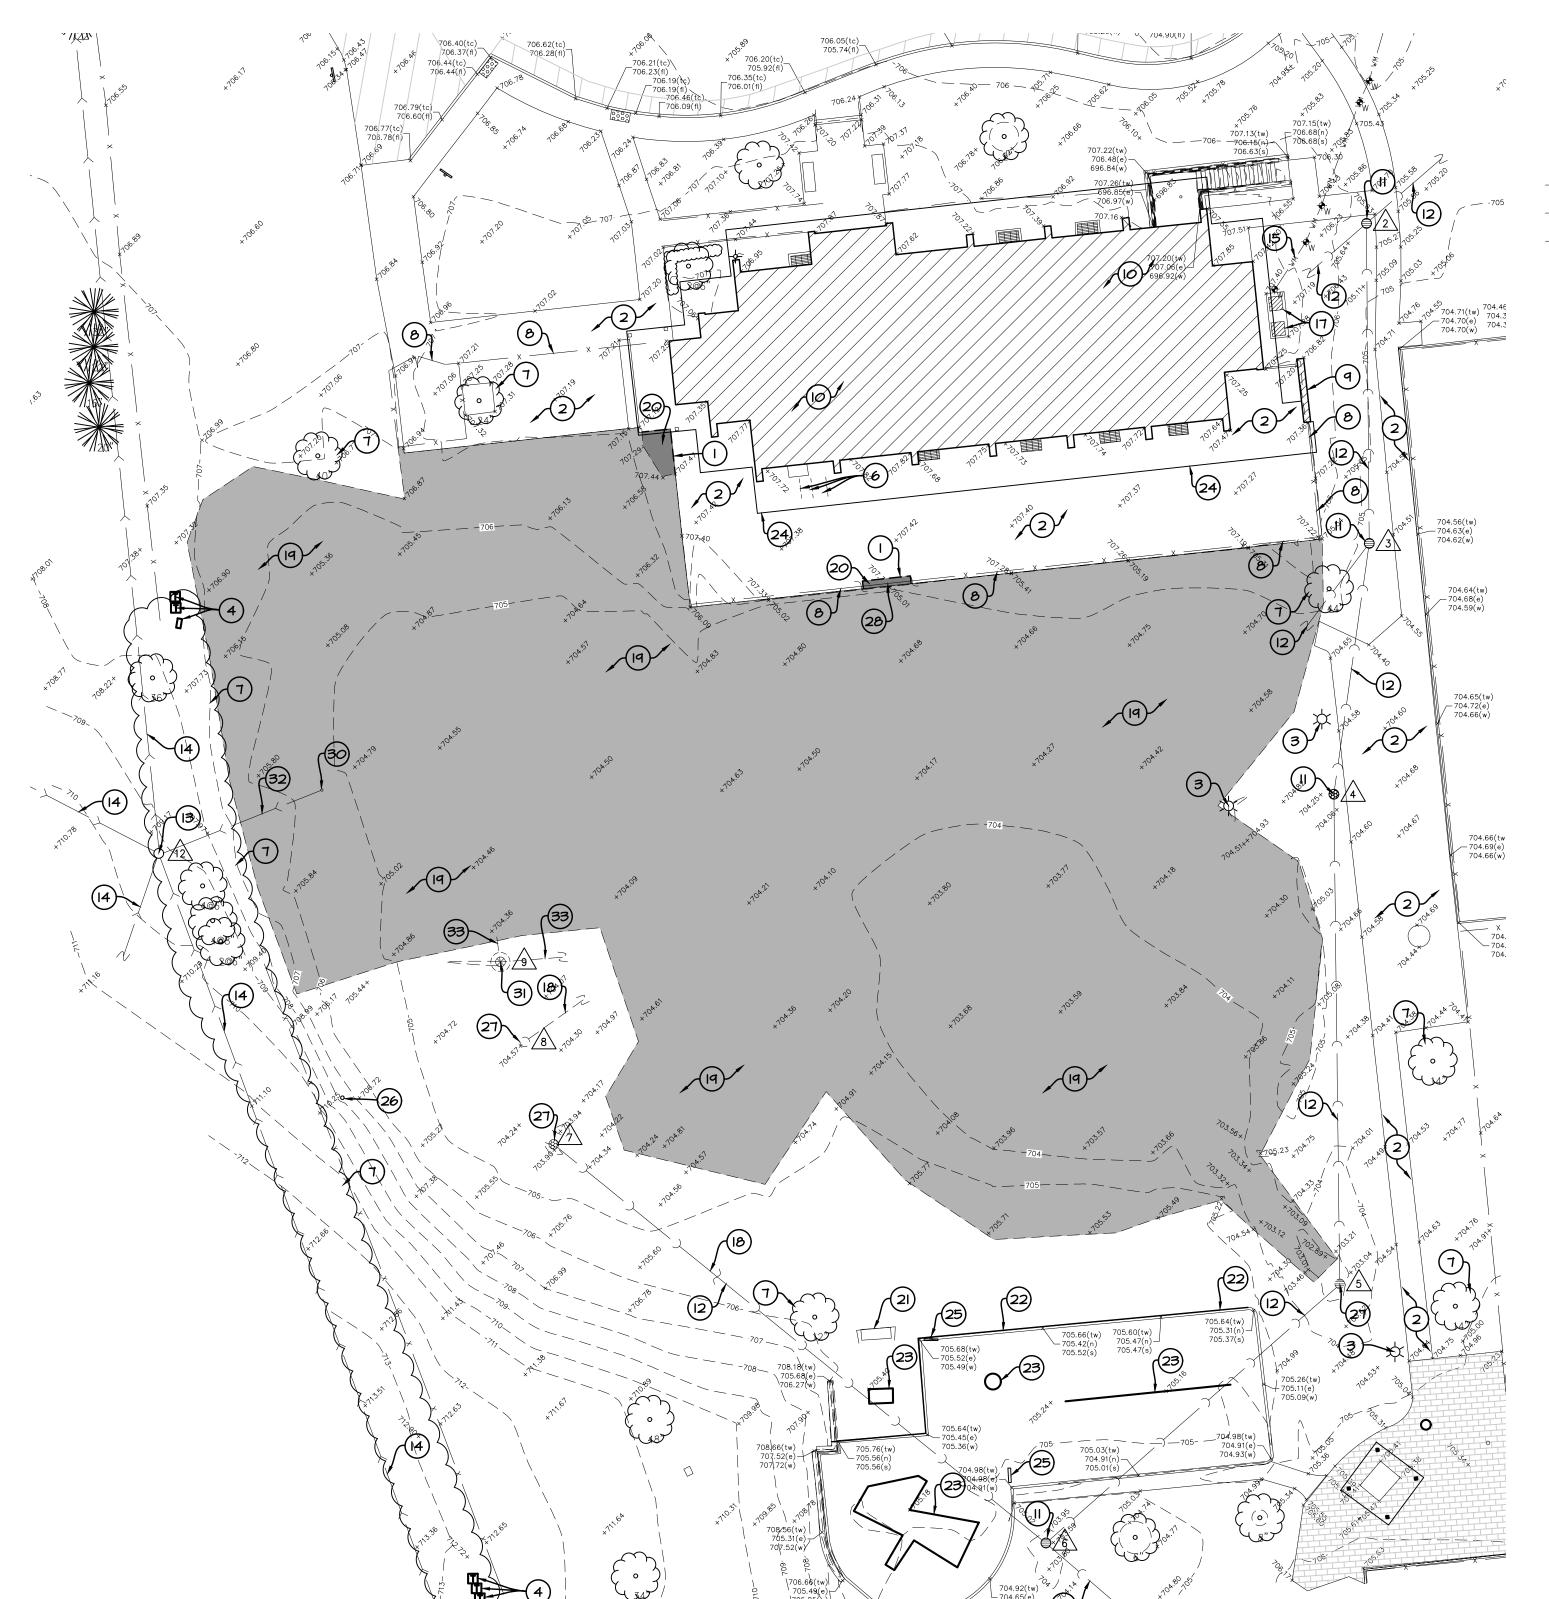
SCALE IN FEET

SHEET NUMBER



NORTH ©2018 Hitchcock Design Group





HATCH LEGEND

EXISTING CONCRETE TO BE REMOVED

EXISTING GRAVEL TO BE REMOVED

DEMOLITION LEGEND

	EXISTING STORM SEWER
	EXISTING SANITARY SEMER
	EXISTING WATER MAIN
0	EXISTING CLOSED MANHOLE
	EXISTING OPEN GRATE MANHOLE
⊗	EXISTING BEEHIVE GRATE MANHOLE
	EXISTING CURB INLET
¢	EXISTING FIRE HYDRANT
(\bigotimes)	EXISTING VALVE VAULT
8	EXISTING B-BOX
©	EXISTING GAS VALVE

EXISTING UTILITY DATA

RIM=704.56' (WATER) 1 48" CONCRETE STRUCTURE 698.23' @ TOP OF PIPE (6" DI WNW,ESE)

RIM=705.52' (STORM)
60" CONCRETE STRUCTURE
INV=698.46' (24" CPP NE,SW)
INV=703.22' (2" PVC SSW)

RIM=704.85' (STORM) 3 60" CONCRETE STRUCTURE NV=698.60' (24" CPP N) INV=698.55' (18" CPP SSW) INV=700.35' (6" CPP SW)

RIM=704.33' (STORM)
48" CONCRETE STRUCTURE
INV=698.78' (24" CPP NNE) INV=698.88' (18" CPP S)

RIM=702.87' (STORM)
48" CONCRETE STRUCTURE INV=699.02' (18" CPP N,SW)

RIM=703.49' (STORM)
48" CONCRETE STRUCTURE
INV=699.27' (12" CPP NW)
INV=699.12' (18" CPP NE) INV=701.79' (6" PVC SE)

RIM=704.99' (STORM)

RIM=704.04' (STORM) 7 48" CONCRETE STRUCTURE INV=702.51' (12" CPP SE)

8 48" CONCRETE STRUCTURE WITH SUMP PUMP BOTTOM OF STRUCTURE=692.88'

∧ RIM=705.01' (WATER) 24" CONCRETE STRUCTURE 701.24' @ TOP OF PIPE (2" DI N/E)

RIM=704.30' (SANITARY) 10 48" CONCRETE STRUCTURE

RIM=703.98' (SANITARY)

1NV=690.38' (8" CLAY NW,SSE)

RIM=709.28' (SANITARY)
48" CONCRETE STRUCTURE INV=699.28' (8" CLAY WNW) INV=698.76' (8" CLAY NNE) INV=699.63' (8" CALY E) INV=698.76' (8" CLAY SSE)

INV=699.53' (8" CLAY SW)

RIM=704.06' (SANITARY) 3\ 48" CONCRETÉ STRUCTURE \(\text{NV=696.36' (6" PVC W)}\)
\text{INV=696.36' (8" CLAY NNE/SSW)}

RIM=712.16' (SANITARY) 48" CONCRETE STRUCTURE INV=704.16' (6" CLAY NW,SSW) INV=703.86' (8" CLAY NNE,ESE)

SITE DEMOLITION NOTES:

- A. CONTRACTOR SHALL PERFORM ALL DEMOLITION WORK IN ACCORDANCE WITH ALL APPLICABLE FEDERAL, STATE, AND LOCAL REQUIREMENTS.
- B. THE CONTRACTOR SHALL OBTAIN ALL NECESSARY DEMOLITION PERMITS AND COORDINATE ALL DEMOLITION WITH THE MUNICIPALITY AND OWNERS REPRESENTATIVE TO ENSURE PROTECTION AND MAINTENANCE OF SANITARY AND WATER UTILITIES AS NECESSARY AND TO PROVIDE STORM WATER CONVEYANCE UNTIL NEW FACILITIES ARE CONSTRUCTED, TESTED, AND PLACED IN OPERATION.
- C. CONTRACTOR SHALL DEVELOP AND IMPLEMENT A DAILY PROGRAM OF DUST CONTROL PROCEDURES PRIOR TO DEMOLITION OF ANY STRUCTURES. MODIFICATION OF DUST CONTROL PROCEDURES SHALL BE PERFORMED BY THE CONTRACTOR TO THE SATISFACTION OF THE MUNICIPALITY AND COMPLY WITH THE NPDES II REQUIREMENTS OF THE ILLINOIS ENVIRONMENTAL PROTECTION AGENCY AND THE INDIVIDUAL STORM WATER POLLUTION PREVENTION PLAN FOR THIS PROJECT. D. ALL EXISTING TREES, BRUSH AND MISCELLANEOUS VEGETATION TO BE REMOVED OR DEMOLISHED SHALL BE REMOVED FROM
- THE SITE AND LEGALLY DISPOSED OF BY THE CONTRACTOR. E. VOIDS LEFT BY ANY ITEM REMOVED UNDER ANY PROPOSED BUILDING, PAVEMENT, OR WALK OR WITHIN 24" THEREOF SHALL BE BACKFILLED WITH ENGINEERED FILL ACCORDING TO THE GEOTECHNICAL REPORT.
- F. ALL EXISTING BUILDINGS, FOUNDATIONS, CONCRETE OR ASPHALT PAYEMENT OR WALKS, CURB AND GUTTER AND MISCELLANEOUS STRUCTURES (INCLUDING, BUT NOT LIMITED TO FENCES, POLES, YARD LIGHTS, ELECTRICAL PANELS, AND MISCELLANEOUS DEBRIS) INDICATED TO BE DEMOLISHED SHALL BE REMOVED OR DEMOLISHED AND REMOVED FROM THE SITE AND DISPOSED OF LEGALLY BY THE CONTRACTOR.

G. CONTACT GAS COMPANY PRIOR TO DEMOLITION. LOCATION OF EXISTING GAS SERVICES ARE UNKNOWN.

- H. ALL EXISTING TREES SHALL REMAIN UNLESS OTHERWISE NOTED. ALL EXISTING UTILITIES SHALL REMAIN UNLESS OTHERWISE NOTED. J. CONTRACTOR SHALL HIRE A PRIVATE UTILITY LOCATOR TO LOCATE UTILITIES PRIOR TO CONSTRUCTION AND SHALL CONTACT THE SITE ENGINEER IF A CONFLICT EXISTS.
- K. CONTRACTOR SHALL PROVIDE REMOVAL AND REPLACEMENT AND SHORING AS NECESSARY TO MEET OSHA AND LOCAL CODE, AS WELL AS MANUFACTURER'S REQUIREMENTS.
- L. ALL FOUNDATIONS FOR ALL FENCES, SIGNS, ETC. NOTED FOR REMOVAL SHALL BE REMOVED AND LEGALLY DISPOSED OF
- M. PROOF-ROLLING SHALL BE PERFORMED FOR ALL SUBGRADE PRIOR TO CONSTRUCTION OF NEW PAVEMENT. ALL SUBGRADE PROOF-ROLLING SHALL BE WITNESSED AND APPROVED BY A MATERIALS TESTING AGENCY TO BE HIRED BY THE OWNER. CONTRACTOR TO COORDINATE ALL PROOF-ROLLING WITH THE MATERIALS TESTING AGENCY. CONTACT THE ENGINEER AND MATERIAL TESTING AGENCY SO THAT THEY MAY WITNESS THE PROOF ROLL. PROOF ROLL SHALL BE PROVIDED FOR ALL PAVEMENT AREAS SPECIFIED FOR FULL DEPTH REMOVAL AND REPLACEMENT.
- N. EXISTING CONDITIONS AND TOPOGRAPHY SHOWN REPRESENTS SITE CONDITIONS PER THE TOPOGRAPHIC SURVEY LAST DATED 3-26-18, PREPARED BY W-T LAND SURVEYING, CONTRACTOR SHALL FIELD VERIFY EXISTING ELEVATIONS AND CONDITIONS (INCLUDING BUT NOT LIMITED TO VERIFICATION OF CONTROL AND ALL UTILITIES WHETHER DEPICTED OR NOT) PRIOR TO CONSTRUCTION AND NOTIFY ENGINEER OF ANY DISCREPANCIES. O. SEE SHEET S-I TOPOGRAPHIC SURVEY FOR ALL EXISTING
- LOCATED UTILITY DATA.
- P. CLEAR SITE AS NECESSARY TO CONSTRUCT PROPOSED IMPROVEMENTS.
- Q. ALL ITEMS MARK "EXISTING OR EXISTING TO REMAIN" TO BE PROTECTED FROM DAMAGE FOR THE DURATION OF CONSTRUCTION.
- R. CONTRACTOR TO PROVIDE SOIL TESTING SERVICES FOR COMPLETION OF THE ILLINOIS ENVIRONMENTAL PROTECTION AGENCY'S LPC-662 AND/OR LPC-663 FORMS AS PART OF THEIR CONTRACT.
- S. ALL EXISTING UTILITIES TO BE ABANDONED IN PLACE SHALL BE CAPPED WITH 2' LONG (MIN.) NON-SHRINK CONCRETE MORTAR

PROJECT NOTES:

- I. NEW FULL DEPTH SAWCUT OF EXISTING CONCRETE PAYEMENT TO PROVIDE CLEAN CONSTRUCTION BREAK.
- 2. EXISTING CONCRETE SIDEWALK TO REMAIN.
- 3. EXISTING AREA LIGHT TO REMAIN.
- 4. EXISTING TELCO PEDESTAL TO REMAIN.
- 5. EXISTING CLEANOUT TO REMAIN. 6. EXISTING HANDRAIL TO REMAIN.
- 7. EXISTING TREE TO REMAIN. PROTECT DURING CONSTRUCTION. 8. EXISTING WROUGHT IRON FENCE TO REMAIN.
- 9. EXISTING RETAINING WALL TO REMAIN. IO. EXISTING BUILDING TO REMAIN.
- II. EXISTING STORM STRUCTURE TO REMAIN.
- 12. EXISTING STORM SEWER TO REMAIN. 13. EXISTING SANITARY STRUCTURE TO REMAIN
- 14. EXISTING SANITARY SEMER TO REMAIN.
- 15. EXISTING WATER MAIN TO REMAIN.
- 16. EXISTING VALVE VAULT TO REMAIN. 17. EXISTING TRANSFORMER TO REMAIN.
- 18. EXISTING STORM SEWER TO BE REMOVED AND CAPPED AT DOWNSTREAM END. 19. EXISTING GRAVEL PAVEMENT TO BE REMOVED AS NECESSARY
- TO INSTALL A MINIMUM OF 12" OF TOPSOIL. 20. EXISTING CONCRETE PAVEMENT TO BE REMOVED FULL DEPTH TO MEET THE BOTTOM OF THE PROPOSED PAVEMENT CROSS SECTIONS (PROPOSED SUBGRADE ELEVATION). SEE THE SITE DEVELOPMENT PLAN FOR THE PROPOSED PAVEMENT CROSS
- SECTIONS AND THE SITE GRADING PLAN FOR THE PROPOSED FINISHED GRADES.
- 21. EXISTING BENCH TO REMAIN. 22. EXISTING CONCRETE BARRIER CURB TO REMAIN.
- 23. EXISTING PLAYGROUND EQUIPMENT TO REMAIN. 24. EXISTING BUILDING OVERHANG TO REMAIN.
- 25. EXISTING SIGN TO REMAIN. 26. EXISTING GAS WITNESS POST TO REMAIN.
- 27. EXISTING STORM STRUCTURE TO BE REMOVED.
- 28. EXISTING WROUGHT IRON FENCE TO BE REMOVED. 29. NOT USED.
- 30. EXISTING CLEANOUT TO BE REMOVED. 31. EXISTING VALVE AND VAULT TO BE REMOVED. 32. EXISTING SANITARY SEWER TO BE ABANDONED IN-PLACE. SEAL
- MORTAR PLUG. 33. EXISTING WATER MAIN TO BE CAPPED WITH A 2' LONG (MIN.) NON-SHRINK CONCRETE MORTAR PLUG.

BOTH PIPE ENDS WITH 2' LONG (MIN.) NON-SHRINK CONCRETE



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Issued

DRAWN BY

DNF/BND

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	March 8, 2019
	REVISIONS
Date	Issue
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	Si .
	6
	Date

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SHEET TITLE Site Demoliton Plan

> SCALE IN FEET as noted

> > SHEET NUMBER

NORTH

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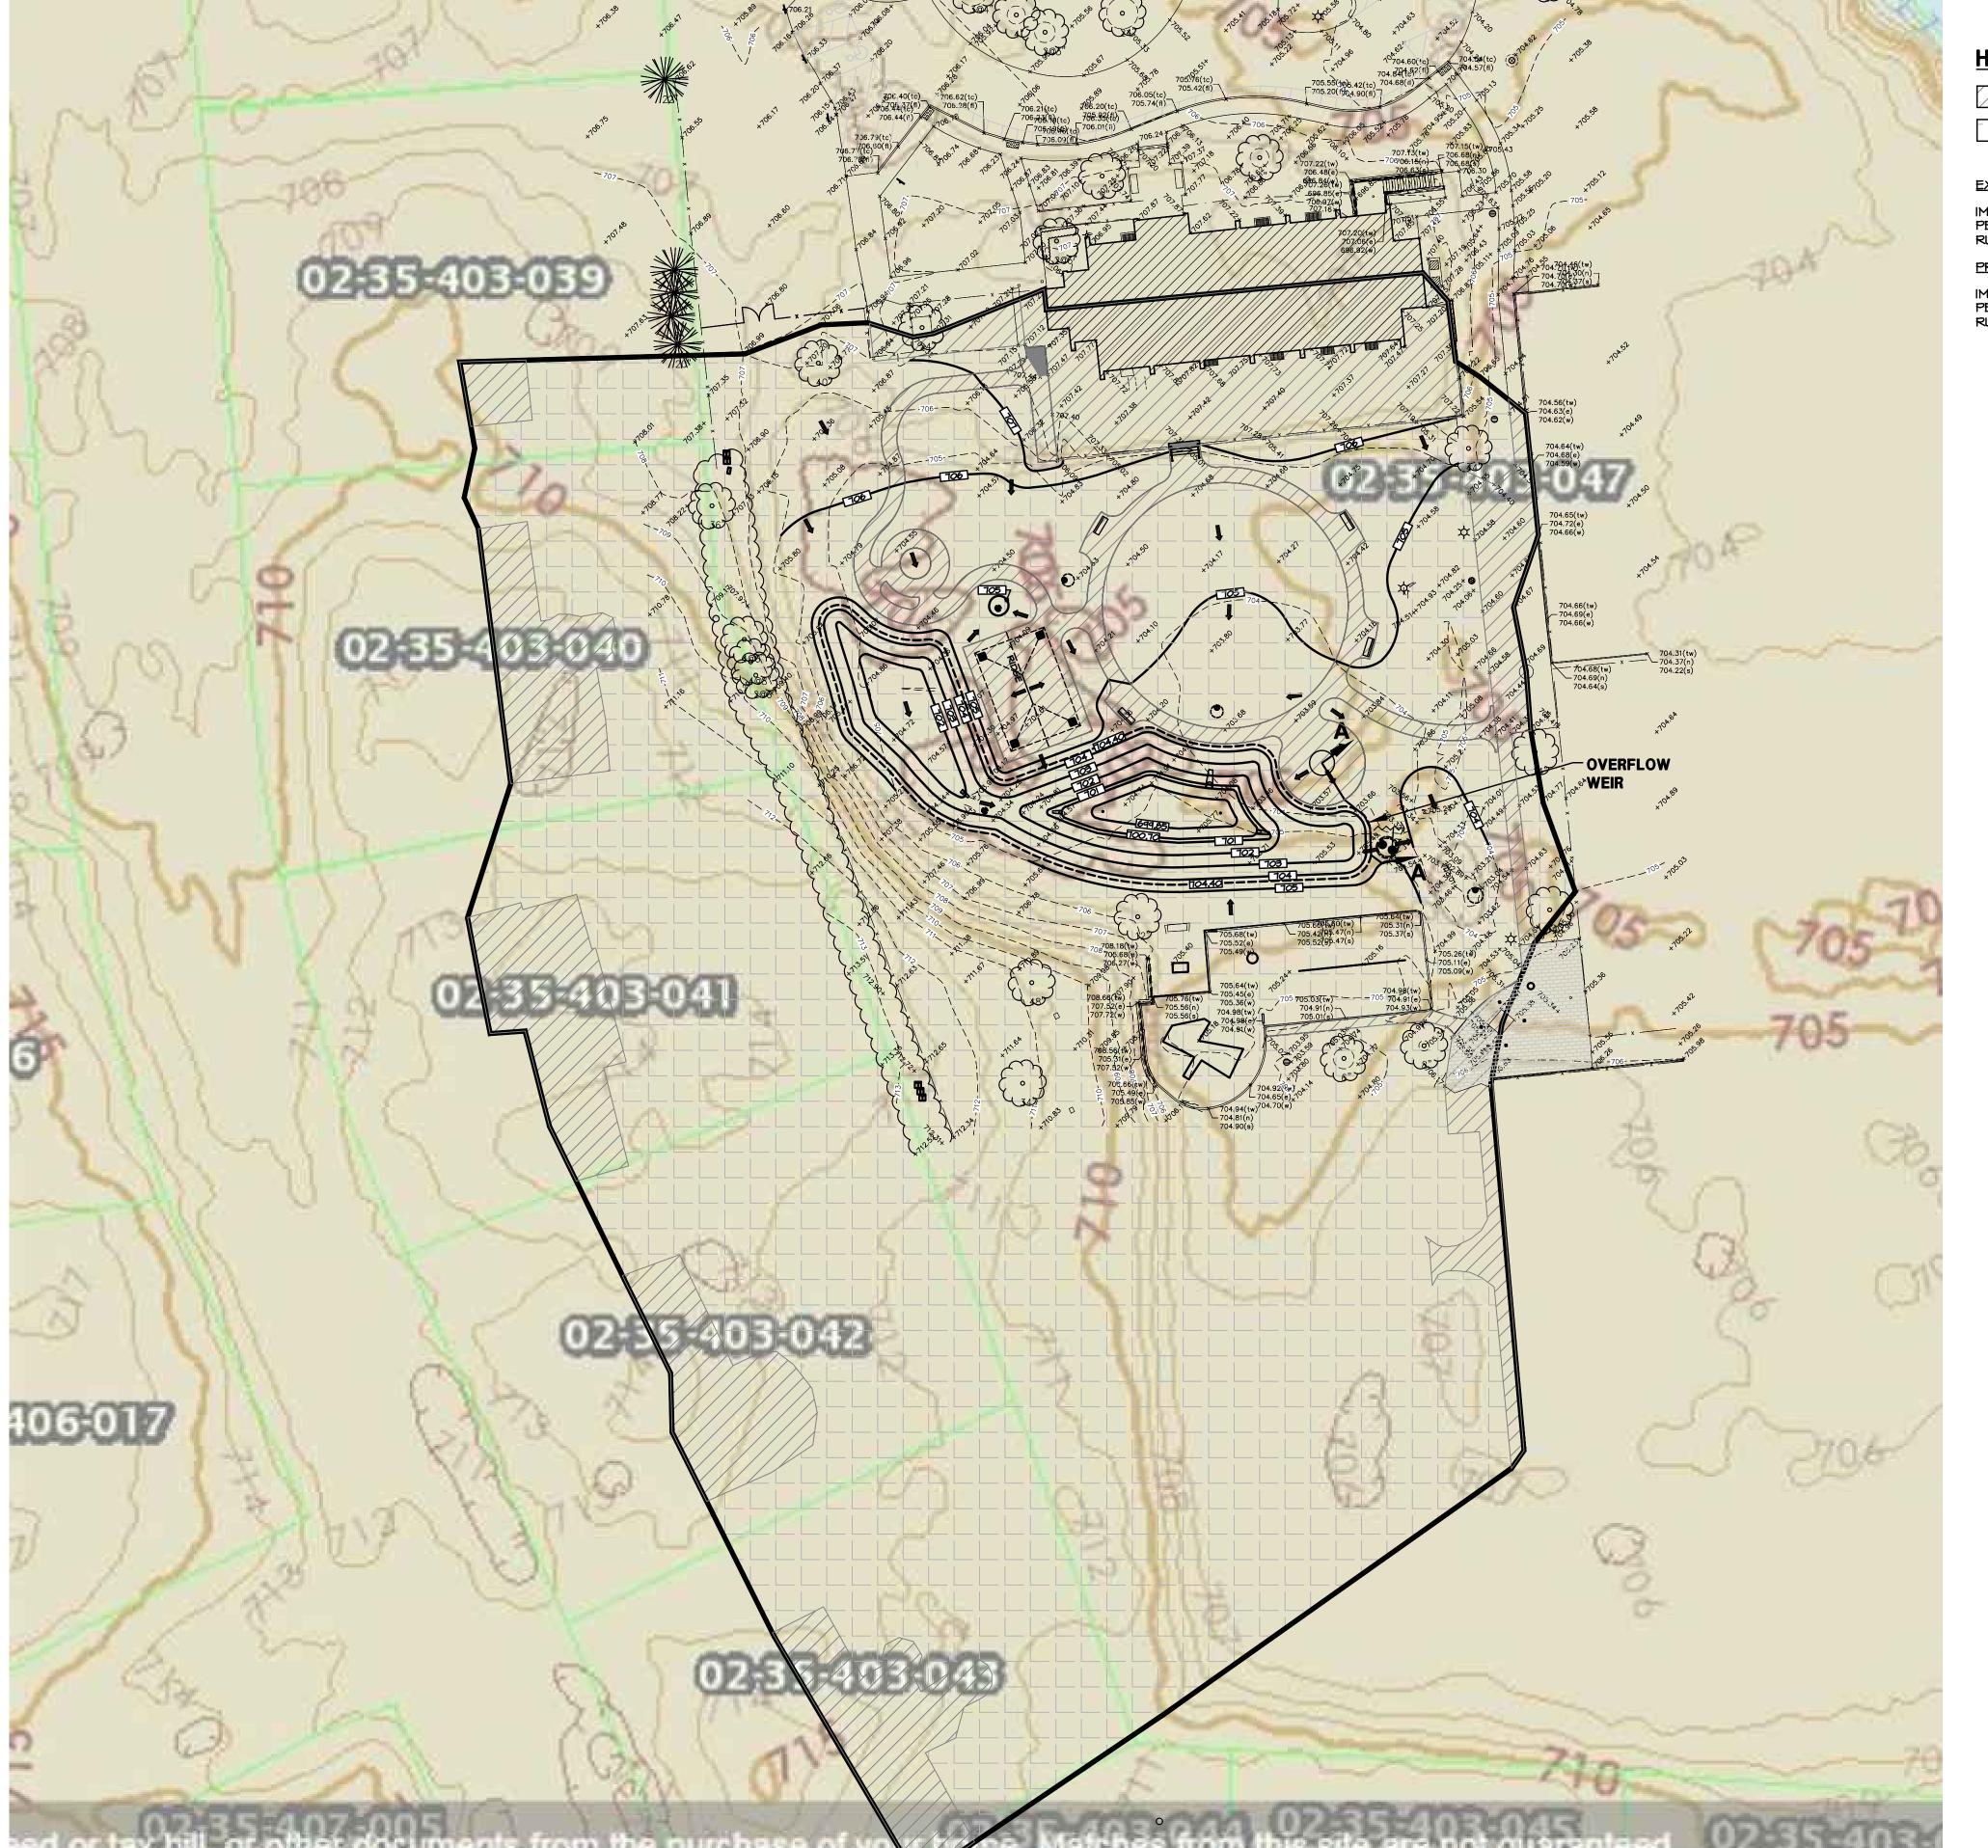
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Hoffman Estates, Illinois 60192 PH: (224) 293-6333 FAX: (224) 293-6444 www.wtengineering.com

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HATCH LEGEND

IMPERVIOUS AREA PERVIOUS AREA

EXISTING CONDITIONS

IMPERVIOUS AREA = 0.476 ACRES PERVIOUS AREA = 2.673 ACRES RUNOFF COEFFICIENT = $[(0.476 \times 0.90) + (2.673 \times 0.45)] / 3.149 = 0.52$

PROPOSED CONDITIONS

IMPERVIOUS AREA = 0.600 ACRES PERVIOUS AREA = 2.549 ACRES RUNOFF COEFFICIENT = $[(0.600 \times 0.90) + (2.549 \times 0.45)] / 3.149 = 0.54$

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		March 8, 2019
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SHEET TITLE IMPERVIOUS / PERVIOUS AREA **EXHIBIT**

SCALE IN FEET


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Project Type (From ab Project Category (From Above)	Media File #/Name	Project Category Cost	ADA Portion of Project Cates % AD	A Dollars Requested
Routes and Surfaces Accessible Routes Means of Egress, Curb R	Ram D & J Landscaping	310437.4	5 102444.36	33.00%
				#DIV/0!

#DIV/0! #DIV/0!
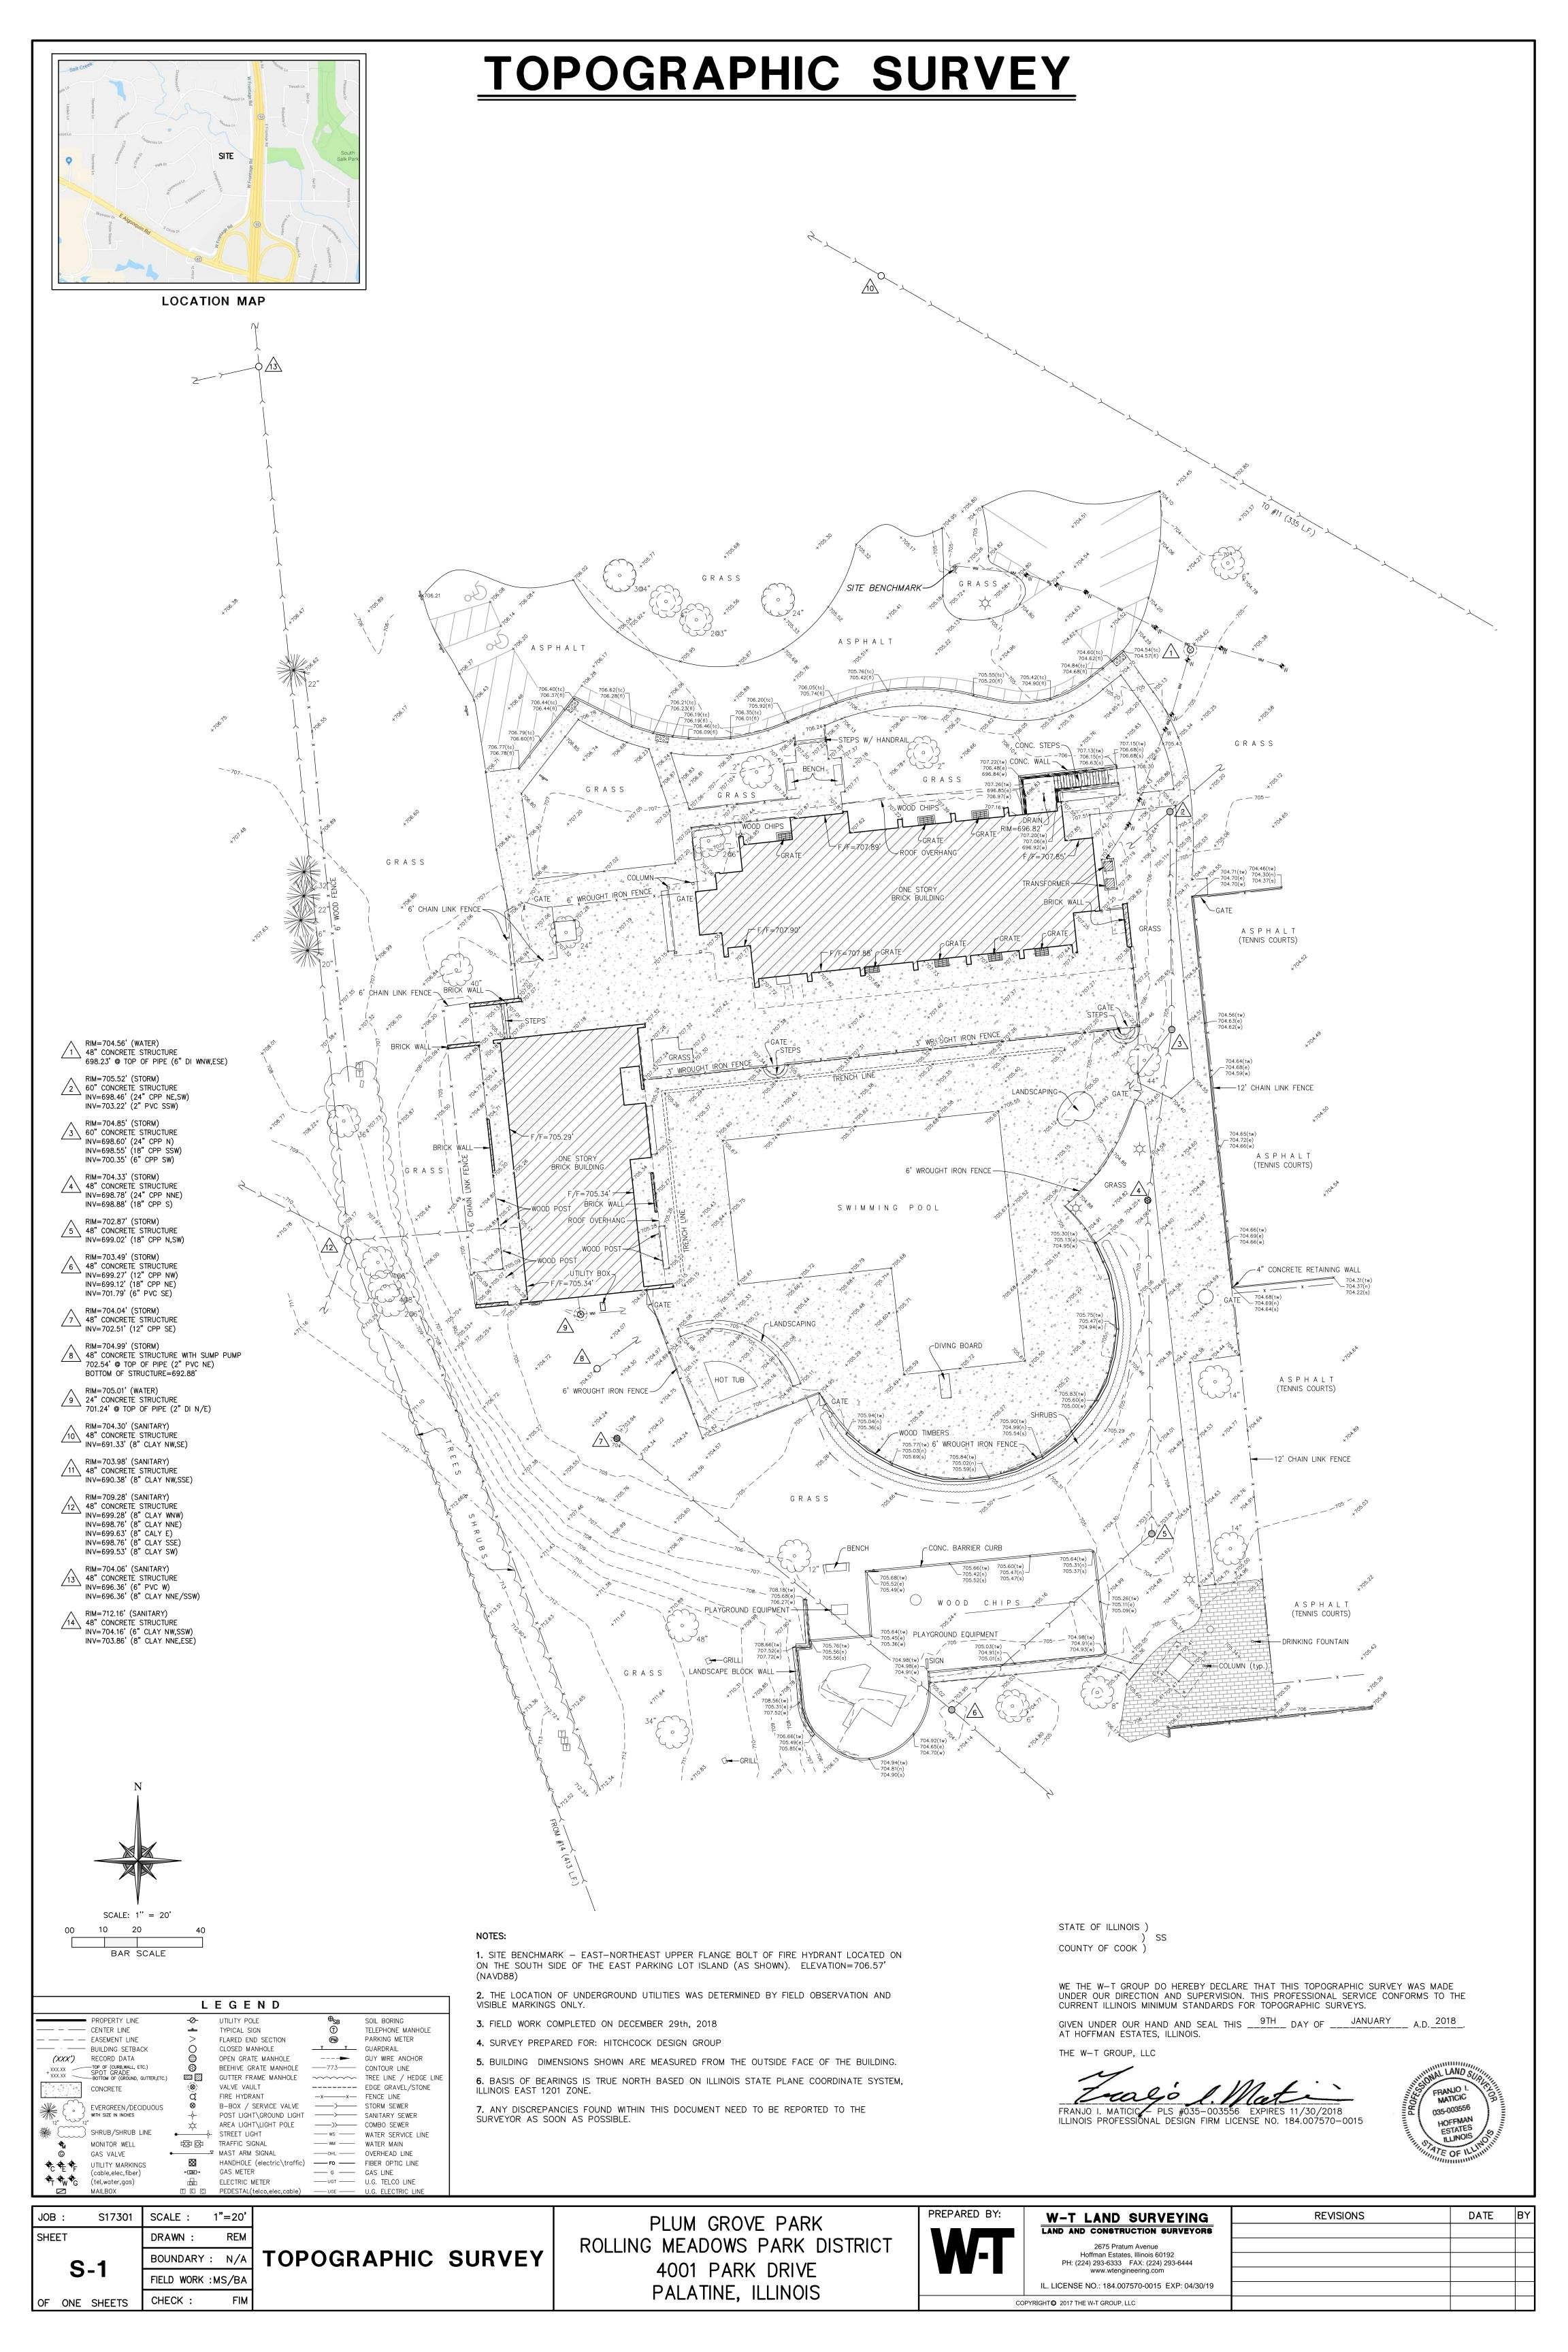
#DIV/0! #DIV/0!

Total Project Cost310437.45Total ADA Portion of Project Cost102444.36Total % of ADA Dollars Requested33.00%