

Evergreen Park Basketball Court

04/15/2024

by Ben Rea in Member District ADA Project Request

410 N. Arlington Heights Road Arlington Heights, Illinois 60004 **United States** 8475067145 ada@ahpd.org

id. 46226561

Original Submission

Title

04/15/2024

Score	n/a
Name	John Kramer
Job Title	Director of Parks & Planning
E-mail Address	jkramer@ahpd.org
Phone Number	8475067145
Park District	Arlington Heights
Project Location	Evergreen Park Basketball Court
Project Status	Maintenance
Project Type	Routes and Surfaces
Routes and Surfaces- select a Project Category below:	Athletic Surfaces
Benefits of the Project	The basketball court had severe cracking and created a safety hazard. The project included complete removal/replacement of the asphalt, shifting the court to the north, color coating, and new lights.
Items that will become ADA Compliant	Basketbalwill continue to be compliant.

The project is designed or constructed, or applies human resources, to comply

with:

Agency's ADA Transition Plan
The 2010 Standards for Accessible Design

The Illinois Accessibility Code

Upload Project Related Files, Photos, Videos or Audio

2023-05-31_EVERGREEN_23-1425_-_REVISED_IFP_PLANS-STAMPED.pdf

Budget Table for ADA Related Expenses

Budget Table.xlsx

ADA Dollars Requested 30800.0

Notes related to requested amount

RECREATION COURT IMPROVEMENTS

EVERGREEN PARK

336 S. FORREST AVE.

ARLINGTON HEIGHTS, IL 60004

FOR:

ARLINGTON HEIGHTS PARK DISTRICT 410 N ARLINGTON HEIGHTS RD ARLINGTON HEIGHTS, IL 60004

Contact the Metropolitan
Water Reclamation District
of Greater Chicago 2 days
before starting work.

P (708) 588-4055

■ WMOJobStart@mwrd.org

J.U.L.I.E.

Note: The Exact Location Of All Utilities Shall Be Verified By The Contractor Prior To Construction Activities. For Utility Locations Call: J.U.L.I.E. 1 (800) 892-0123

SURVEY PROVIDED BY:

Topographic Map Provided By Norman J. Toberman and Associates For Arlington Heights Park District on December

BENCHMARKS

EVERGREEN PARK

Bench Mark

Manhole Rim
Elev. = 673.62 (NAVD88)


Control Point No. 1 (Chiseled Cross)

N1971166.10 E1085450.34 Elev. = 672.51

Control Point No. 2 (Chiseled Cross) N1971062.63

E1085329.28 Elev. = 673.83

Elevations Shown Hereon Are Based On The NAVD88 Datum Plane.

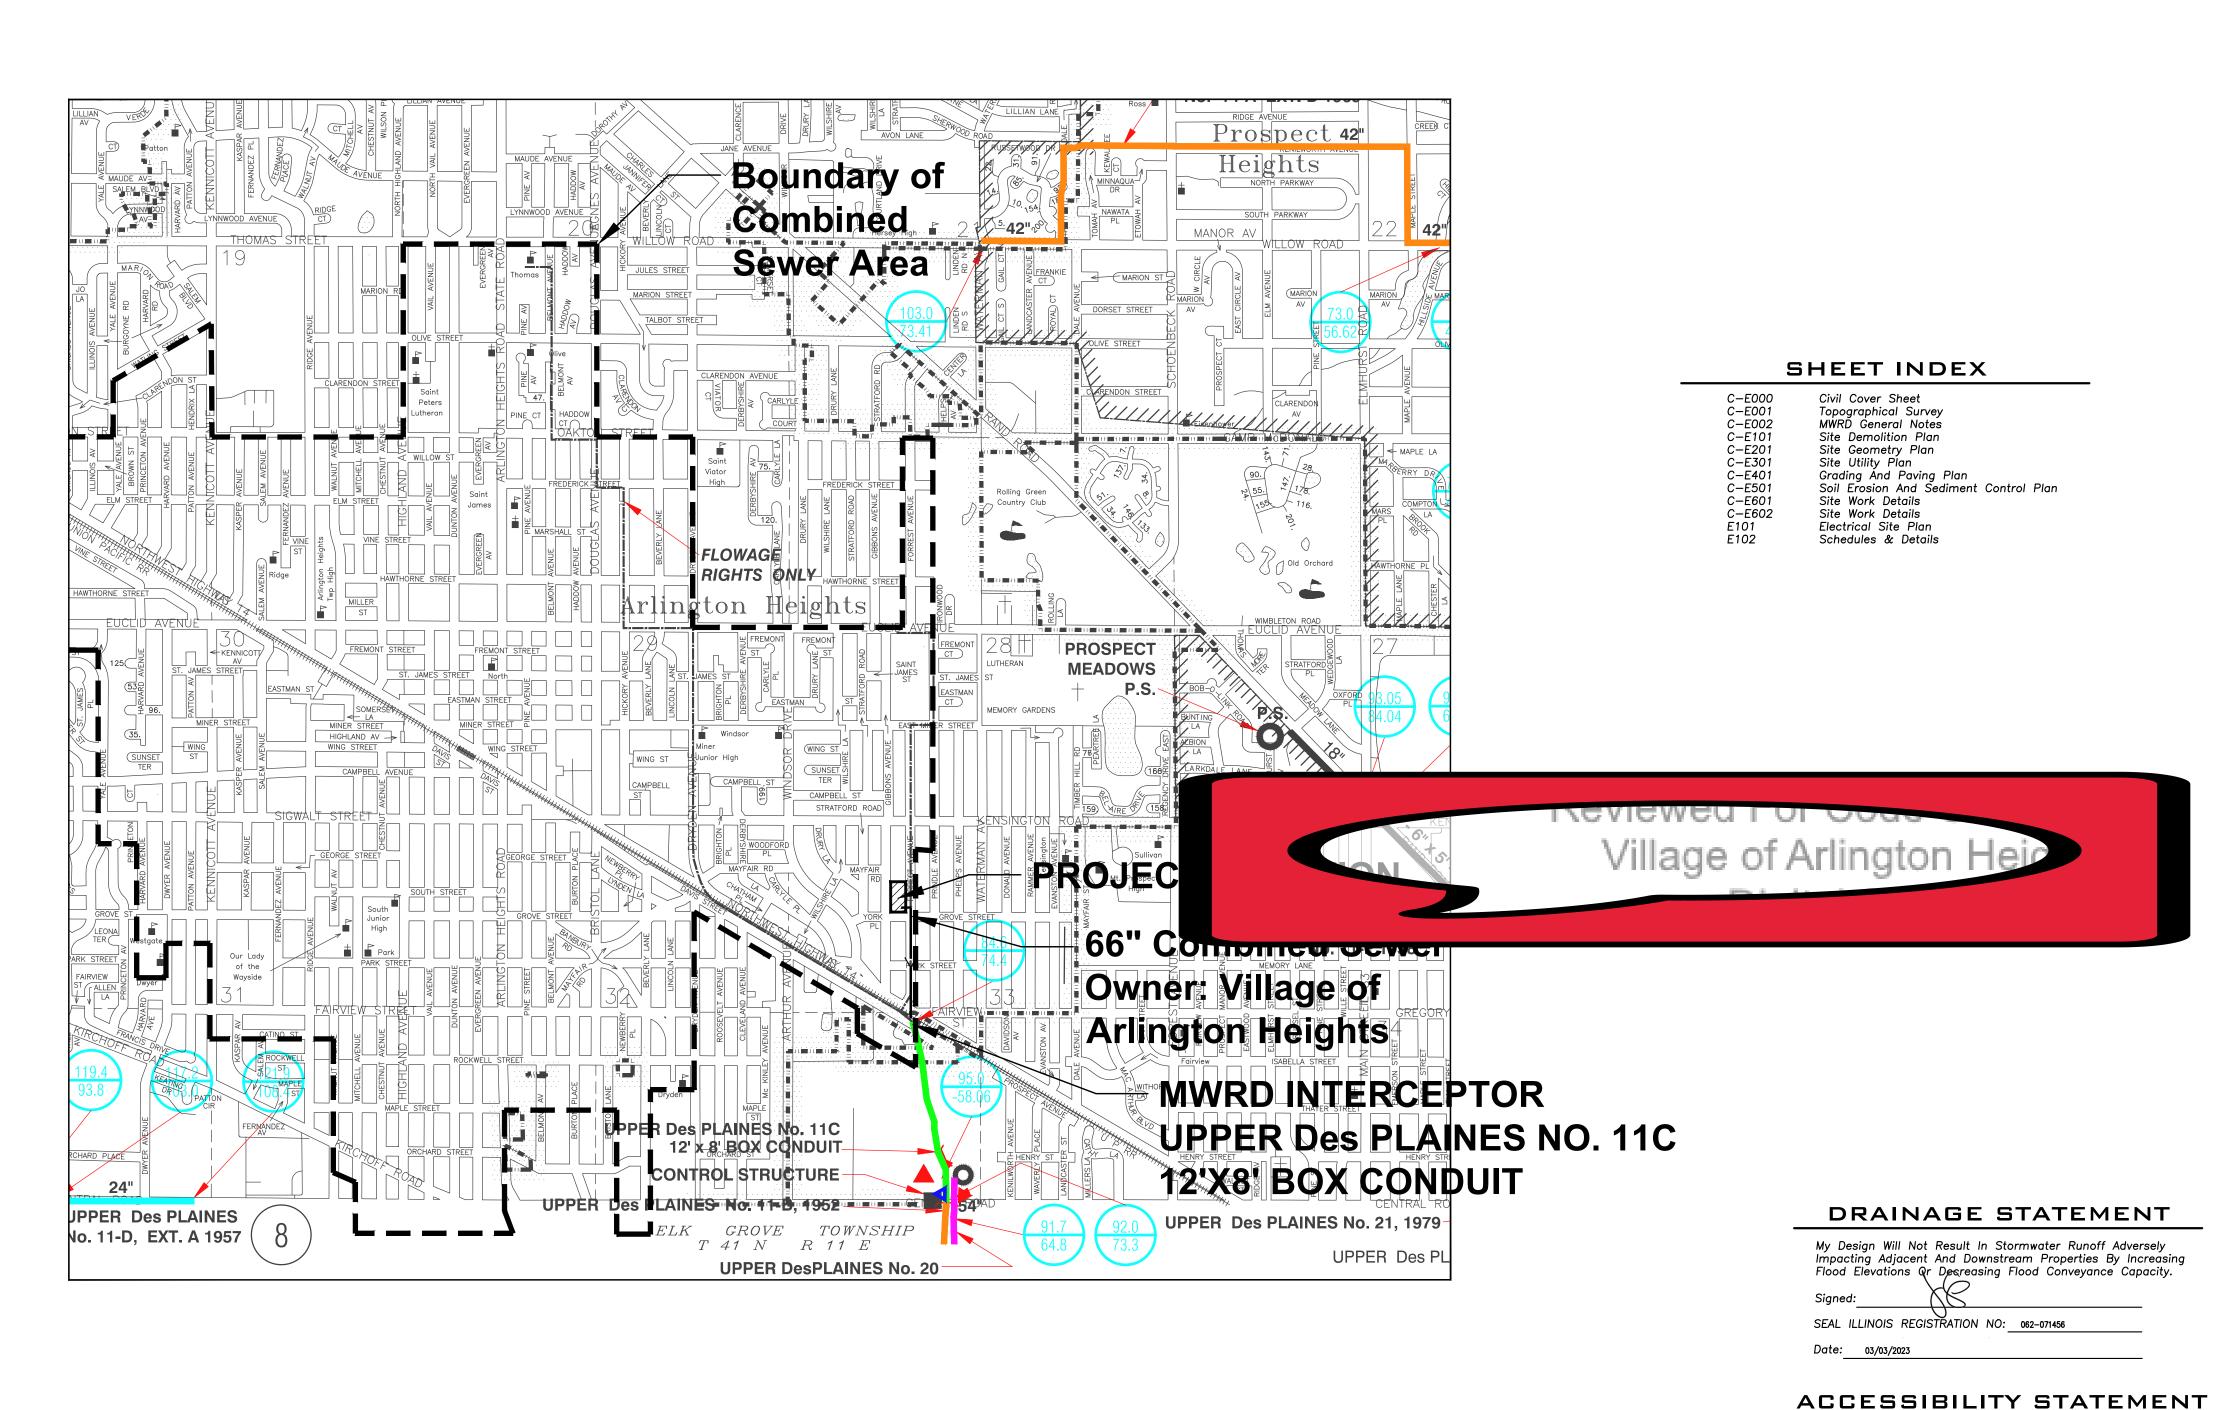

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ASSOCIATES, LTD.

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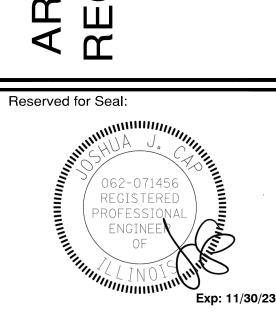
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EXPIRES: 04/30/2023

ION COURT IMPROVEM
EVERGREEN PARK
36 S. FORREST AVENUE



RE

		Exp: 11/30/2
No.	Date	Description
	03/15/23	Issued For Permit
1	05/31/23	Revised For Village Permit
@ F.P	IKSSON ENGIN	IEEDING ASSOCIATES LTD. 2022

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Design By: Approved By: Date:

NH JC 02/17/23

Sheet Title:

OF COMPLIANCE

Supervision, The Attached Plans And Specifications And State That,

To The Best Of My Knowledge And Belief And To The Extent Of My

I Have Prepared, Or Caused To Be Prepared Under My Direct


Contractual Obligation, They Are In Compliance With The Environmental Barriers Act [410 ILCS 25] And The Illinois

Accessibility Code (71 III. Adm. Code 400).

SEAL ILLINOIS REGISTRATION NO: 062-071456

CIVIL COVER SHEET


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ING I ON HEIGHTS PARK DISTRICT REATION COURT IMPROVEMENTS EVERGREEN PARK

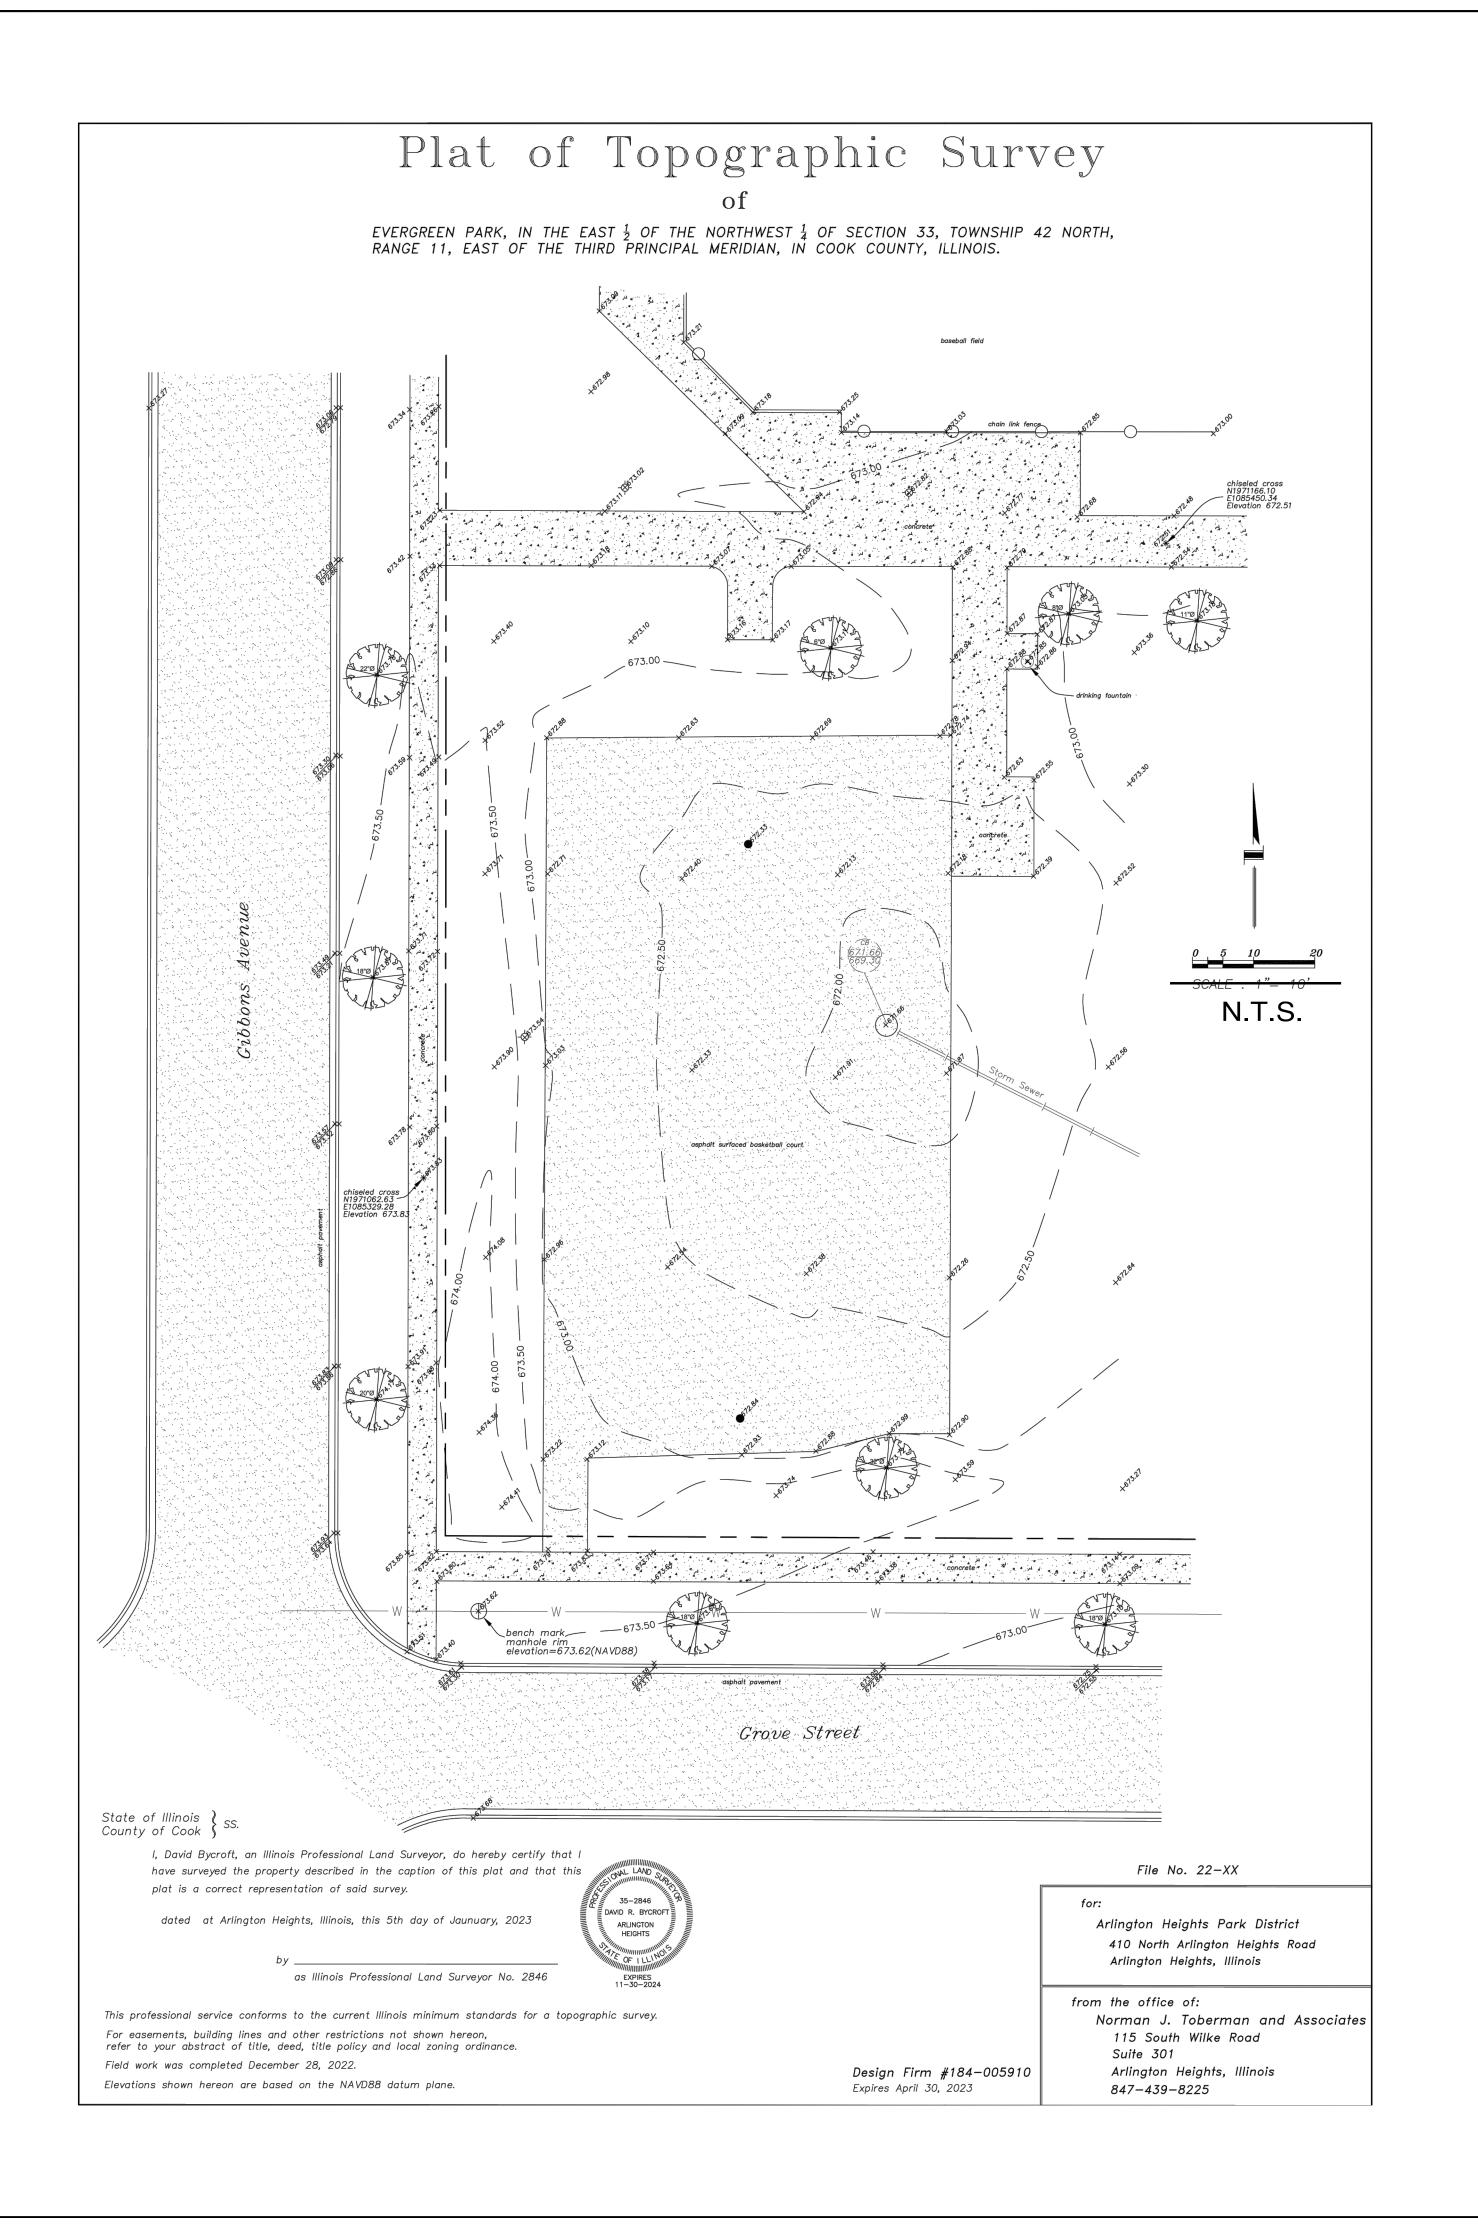

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Design By: Approved By: Date:

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Sheet Title:

TOPOGRAPHICAL SURVEY

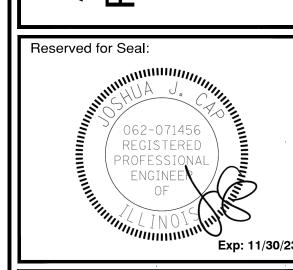Sheet No

A. REFERENCED SPECIFICATIONS

- ALL CONSTRUCTION SHALL BE IN ACCORDANCE WITH THE APPLICABLE SECTIONS OF THE FOLLOWING, EXCEPT AS MODIFIED HEREIN OR ON THE PLANS:
- * STANDARD SPECIFICATIONS FOR ROAD AND BRIDGE CONSTRUCTION (LATEST EDITION), BY THE ILLINOIS DEPARTMENT OF TRANSPORTATION (IDOT SS) FOR ALL IMPROVEMENTS EXCEPT SANITARY
- SEWER AND WATER MAIN CONSTRUCTION;
 * STANDARD SPECIFICATIONS FOR WATER AND SEWER MAIN CONSTRUCTION IN ILLINOIS, LATEST
- EDITION (SSWS) FOR SANITARY SEWER AND WATER MAIN CONSTRUCTION;

 * VILLAGE OF ARLINGTON HEIGHTS MUNICIPAL CODE;
- * THE METROPOLITAN WATER RECLAMATION DISTRICT OF GREATER CHICAGO (MWRD) WATERSHED MANAGEMENT ORDINANCE AND TECHNICAL GUIDANCE MANUAL;
- * IN CASE OF CONFLICT BETWEEN THE APPLICABLE ORDINANCES NOTED, THE MORE STRINGENT SHALL TAKE PRECEDENCE AND SHALL CONTROL ALL CONSTRUCTION.

B. NOTIFICATIONS

C. GENERAL NOTES

- 2. THE VILLAGE OF <u>HEIGHTS</u> ENGINEERING DEPARTMENT AND PUBLIC MUST BE NOTIFIED AT LEAST 24 HOURS PRIOR TO THE START OF CONSTRUCTION AND PRIOR TO EACH PHASE OF WORK. CONTRACTOR SHALL DETERMINE ITEMS REQUIRING INSPECTION PRIOR TO START OF CONSTRUCTION OR EACH WORK PHASE.
- 3. THE CONTRACTOR SHALL NOTIFY ALL UTILITY COMPANIES PRIOR TO BEGINNING CONSTRUCTION FOR THE EXACT LOCATIONS OF UTILITIES AND FOR THEIR PROTECTION DURING CONSTRUCTION. IF EXISTING UTILITIES ARE ENCOUNTERED THAT CONFLICT IN LOCATION WITH NEW CONSTRUCTION, IMMEDIATELY NOTIFY THE ENGINEER SO THAT THE CONFLICT CAN BE RESOLVED. CALL J.U.L.I.E. AT 1-800-892-0123.
- 1. ALL ELEVATIONS SHOWN ON PLANS REFERENCE THE NORTH AMERICAN VERTICAL DATUM OF 1988 (NAVD88). CONVERSION FACTOR IS ___N/A__ FT.
- 2. MWRD, THE MUNICIPALITY AND THE OWNER OR OWNER'S REPRESENTATIVE SHALL HAVE THE AUTHORITY TO INSPECT, APPROVE, AND REJECT THE CONSTRUCTION IMPROVEMENTS.
- 3. THE CONTRACTOR(S) SHALL INDEMNIFY THE OWNER, ENGINEER, MUNICIPALITY, MWRD, AND THEIR AGENTS, ETC., FROM ALL LIABILITY INVOLVED WITH THE CONSTRUCTION, INSTALLATION, OR TESTING OF THIS WORK ON THE PROJECT.
- 4. THE PROPOSED IMPROVEMENTS MUST BE CONSTRUCTED IN ACCORDANCE WITH THE ENGINEERING PLANS AS APPROVED BY MWRD AND THE MUNICIPALITY UNLESS CHANGES ARE APPROVED BY MWRD, THE MUNICIPALITY, OR AUTHORIZED AGENT. THE CONSTRUCTION DETAILS, AS PRESENTED ON THE PLANS, MUST BE FOLLOWED. PROPER CONSTRUCTION TECHNIQUES MUST BE FOLLOWED ON THE IMPROVEMENTS INDICATED ON THE PLANS.
- 5. THE LOCATION OF VARIOUS UNDERGROUND UTILITIES WHICH ARE SHOWN ON THE PLANS ARE FOR INFORMATION ONLY AND REPRESENT THE BEST KNOWLEDGE OF THE ENGINEER. VERIFY LOCATIONS AND ELEVATIONS PRIOR TO BEGINNING THE CONSTRUCTION OPERATIONS.
- 6. ANY EXISTING PAVEMENT, SIDEWALK, DRIVEWAY, ETC., DAMAGED DURING CONSTRUCTION OPERATIONS AND NOT CALLED FOR TO BE REMOVED SHALL BE REPLACED AT THE EXPENSE OF THE CONTRACTOR.
- 7. MATERIAL AND COMPACTION TESTING SHALL BE PERFORMED IN ACCORDANCE WITH THE REQUIREMENTS OF THE MUNICIPALITY, MWRD, AND OWNER.
- 8. THE UNDERGROUND CONTRACTOR SHALL MAKE ALL NECESSARY ARRANGEMENTS TO NOTIFY ALL INSPECTION AGENCIES.
- 9. ALL NEW AND EXISTING UTILITY STRUCTURES ON SITE AND IN AREAS DISTURBED DURING CONSTRUCTION SHALL BE ADJUSTED TO FINISH GRADE PRIOR TO FINAL INSPECTION.
- 10. RECORD DRAWINGS SHALL BE KEPT BY THE CONTRACTOR AND SUBMITTED TO THE ENGINEER AS SOON AS UNDERGROUND IMPROVEMENTS ARE COMPLETED. FINAL PAYMENTS TO THE CONTRACTOR SHALL BE HELD UNTIL THEY ARE RECEIVED. ANY CHANGES IN LENGTH, LOCATION OR ALIGNMENT SHALL BE SHOWN IN RED. ALL WYES OR BENDS SHALL BE LOCATED FROM THE DOWNSTREAM MANHOLE. ALL VALVES, B-BOXES, TEES OR BENDS SHALL BE TIED TO A FIRE HYDRANT.

D. SANITARY SEWER

- I. THE CONTRACTOR SHALL TAKE MEASURES TO PREVENT ANY POLLUTED WATER, SUCH AS GROUND AND SURFACE WATER, FROM ENTERING THE EXISTING SANITARY SEWERS.
- 2. A WATER-TIGHT PLUG SHALL BE INSTALLED IN THE DOWNSTREAM SEWER PIPE AT THE POINT OF SEWER CONNECTION PRIOR TO COMMENCING ANY SEWER CONSTRUCTION. THE PLUG SHALL REMAIN IN PLACE UNTIL REMOVAL IS AUTHORIZED BY THE MUNICIPALITY AND/OR MWRD AFTER THE SEWERS HAVE BEEN TESTED AND ACCEPTED.
- 3. DISCHARGING ANY UNPOLLUTED WATER INTO THE SANITARY SEWER SYSTEM FOR THE PURPOSE OF SEWER FLUSHING OF LINES FOR THE DEFLECTION TEST SHALL BE PROHIBITED WITHOUT PRIOR APPROVAL FROM THE MUNICIPALITY OR MWRD.

 4. ALL SANITARY SEWER CONSTRUCTION SHALL BE IN ACCORDANCE WITH THE STANDARD SPECIFICATIONS
- 1. ALL SANITARY SEWER CONSTRUCTION SHALL BE IN ACCORDANCE WITH THE STANDARD SPECIFICATIONS FOR WATER AND SEWER MAIN CONSTRUCTION IN ILLINOIS (LATEST EDITION).
- 5. ALL FLOOR DRAINS SHALL DISCHARGE TO THE SANITARY SEWER SYSTEM.
- $\hbox{6. ALL DOWNSPOUTS AND FOOTING DRAINS SHALL DISCHARGE TO THE STORM SEWER SYSTEM. } \\$
- 7. ALL SANITARY SEWER PIPE MATERIALS AND JOINTS (AND STORM SEWER PIPE MATERIALS AND JOINTS IN A COMBINED SEWER AREA) SHALL CONFORM TO THE FOLLOWING:

	<u>PIPE MATERIAL</u> VITRIFIED CLAY PIPE	PIPE SPECIFICATIONS ASTM C-700	JOINT SPECIFICATIONS ASTM C-425
	REINFORCED CONCRETE SEWER PIPE	ASTM C-76	ASTM C-443
	CAST IRON SOIL PIPE	ASTM A-74	ASTM C-564
	DUCTILE IRON PIPE	ANSI A21.51	ANSI A21.11
	POLYVINYL CHLORIDE (PVC) PIPE 6-INCH TO 15-INCH DIAMETER SDR 26 18-INCH TO 27-INCH DIAMETER F/DY=46	ASTM D-3034 ASTM F-679	ASTM D-3212 ASTM D-3212
	HIGH DENSITY POLYETHYLENE (HDPE)	ASTM D-3350 ASTM D-3035	ASTM D-3261,F-2620 (HEAT FUSION ASTM D-3212,F-477 (GASKETED)
1	WATER MAIN QUALITY PVC 4-INCH TO 36-INCH 4-INCH TO 12-INCH 14-INCH TO 48-INCH	ASTM D-2241 AWWA C900 AWWA C905	ASTM D-3139 ASTM D-3139 ASTM D-3139

THE FOLLOWING MATERIALS ARE ALLOWED ON A QUALIFIED BASIS SUBJECT TO DISTRICT REVIEW AND APPROVAL PRIOR TO PERMIT ISSUANCE. A SPECIAL CONDITION WILL BE ADDED TO THE PERMIT WHEN THE PIPE MATERIAL BELOW IS USED FOR SEWER CONSTRUCTION OR A CONNECTION IS MADE.

PIPE MATERIAL POLYPROPYLENE (PP) PIPE	PIPE SPECIFICATIONS	JOINT SPECIFICATIONS
12-INCH TO 24-INCH DOUBLE WALL	ASTM F-2736	D-3212, F-477
30-INCH TO 60-INCH TRIPLE WALL	ASTM F-2764	D3212, F-477

- 8. ALL SANITARY SEWER CONSTRUCTION (AND STORM SEWER CONSTRUCTION IN COMBINED SEWER AREAS), REQUIRES STONE BEDDING WITH STONE ¼ "TO 1" IN SIZE, WITH MINIMUM BEDDING THICKNESS EQUAL TO ¼ THE OUTSIDE DIAMETER OF THE SEWER PIPE, BUT NOT LESS THAN FOUR (4) INCHES NOR MORE THAN EIGHT (8) INCHES. MATERIAL SHALL BE CA-7, CA-11 OR CA-13 AND SHALL BE EXTENDED AT LEAST 12" ABOVE THE TOP OF THE PIPE WHEN USING PVC.
- 9. NON-SHEAR FLEXIBLE-TYPE COUPLINGS SHALL BE USED IN THE CONNECTION OF SEWER PIPES OF DISSIMILAR PIPE MATERIALS.
- 10. ALL MANHOLES SHALL BE PROVIDED WITH BOLTED, WATERTIGHT COVERS. SANITARY LIDS SHALL BE CONSTRUCTED WITH A CONCEALED PICKHOLE AND WATERTIGHT GASKET WITH THE WORD "SANITARY" CAST INTO THE LID.
- 11. WHEN CONNECTING TO AN EXISTING SEWER MAIN BY MEANS OTHER THAN AN EXISTING WYE, TEE, OR AN EXISTING MANHOLE, ONE OF THE FOLLOWING METHODS SHALL BE USED:
- a) A CIRCULAR SAW-CUT OF SEWER MAIN BY PROPER TOOLS ("SHEWER-TAP" MACHINE OR SIMILAR)
 AND PROPER INSTALLATION OF HUBWYE SADDLE OR HUB-TEE SADDLE.
 b) REMOVE AN ENTIRE SECTION OF PIPE (BREAKING ONLY THE TOP OF ONE BELL) AND REPLACE WITH
- A WYE OR TEE BRANCH SECTION.
 c) WITH PIPE CUTTER, NEATLY AND ACCURATELY CUT OUT DESIRED LENGTH OF PIPE FOR INSERTION OF PROPER FITTING, USING "BAND SEAL" OR SIMILAR COUPLINGS TO HOLD IT FIRMLY IN PLACE.
- 12. WHENEVER A SANITARY/COMBINED SEWER CROSSES UNDER A WATERMAIN, THE MINIMUM VERTICAL DISTANCE FROM THE TOP OF THE SEWER TO THE BOTTOM OF THE WATERMAIN SHALL BE 18 INCHES. FURTHERMORE, A MINIMUM HORIZONTAL DISTANCE OF 10 FEET BETWEEN SANITARY/COMBINED SEWERS AND WATERMAINS SHALL BE MAINTAINED UNLESS: THE SEWER IS LAID IN A SEPARATE TRENCH, KEEPING A MINIMUM 18" VERTICAL SEPARATION; OR THE SEWER IS LAID IN THE SAME TRENCH WITH THE WATERMAIN LOCATED AT THE OPPOSITE SIDE ON A BENCH OF UNDISTURBED EARTH, KEEPING A MINIMUM 18" VERTICAL SEPARATION. IF EITHER THE VERTICAL OR HORIZONTAL DISTANCES DESCRIBED CANNOT BE MAINTAINED, OR THE SEWER CROSSES ABOVE THE WATER MAIN, THE SEWER SHALL BE CONSTRUCTED TO WATER MAIN STANDARDS OR IT SHALL BE ENCASED WITH A WATER MAIN QUALITY CARRIER PIPE WITH THE ENDS SEALED.
- 13. ALL EXISTING SEPTIC SYSTEMS SHALL BE ABANDONED. ABANDONED TANKS SHALL BE FILLED WITH GRANULAR MATERIAL OR REMOVED.
- 14. ALL SANITARY MANHOLES, (AND STORM MANHOLES IN COMBINED SEWER AREAS), SHALL HAVE A MINIMUM INSIDE DIAMETER OF 48 INCHES, AND SHALL BE CAST IN PLACE OR PRE-CAST REINFORCED CONCRETE.
- 15. ALL SANITARY MANHOLES, (AND STORM MANHOLES IN COMBINED SEWER AREAS), SHALL HAVE PRECAST "RUBBER BOOTS" THAT CONFORM TO ASTM C-923 FOR ALL PIPE CONNECTIONS. PRECAST SECTIONS SHALL CONSIST OF MODIFIED GROOVE TONGUE AND RUBBER GASKET TYPE JOINTS.
- 16. ALL ABANDONED SANITARY SEWERS SHALL BE PLUGGED AT BOTH ENDS WITH AT LEAST 2 FEET LONG NON-SHRINK CONCRETE OR MORTAR PLUG.
- 17. EXCEPT FOR FOUNDATION/FOOTING DRAINS PROVIDED TO PROTECT BUILDINGS, OR PERFORATED PIPES ASSOCIATED WITH VOLUME CONTROL FACILITIES, DRAIN TILES/FIELD TILES/UNDERDRAINS/PERFORATED PIPES ARE NOT ALLOWED TO BE CONNECTED TO OR TRIBUTARY TO COMBINED SEWERS, SANITARY SEWERS, OR STORM SEWERS TRIBUTARY TO COMBINED SEWERS IN COMBINED SEWER AREAS. CONSTRUCTION OF NEW FACILITIES OF THIS TYPE IS PROHIBITED; AND ALL EXISTING DRAIN TILES AND PERFORATED PIPES ENCOUNTERED WITHIN THE PROJECT AREA SHALL BE PLUGGED OR REMOVED, AND SHALL NOT BE CONNECTED TO COMBINED SEWERS, SANITARY SEWERS, OR STORM SEWERS TRIBUTARY TO COMBINED SEWERS.
- 18. A BACKFLOW PREVENTER IS REQUIRED FOR ALL DETENTION BASINS TRIBUTARY TO COMBINED SEWERS. REQUIRED BACKFLOW PREVENTERS SHALL BE INSPECTED AND EXERCISED ANNUALLY BY THE PROPERTY OWNER TO ENSURE PROPER OPERATION, AND ANY NECESSARY MAINTENANCES SHALL BE PERFORMED TO ENSURE FUNCTIONALITY. IN THE EVENT OF A SEWER SURCHARGE INTO AN OPEN DETENTION BASIN TRIBUTARY TO COMBINED SEWERS, THE PERMITTEE SHALL ENSURE THAT CLEAN UP AND WASH OUT OF SEWAGE TAKES PLACE WITHIN 48 HOURS OF THE STORM EVENT.

- E. EROSION AND SEDIMENT CONTROL
- 1. THE CONTRACTOR SHALL INSTALL THE EROSION AND SEDIMENT CONTROL DEVICES AS SHOWN ON THE APPROVED EROSION AND SEDIMENT CONTROL PLAN.
- 2. EROSION AND SEDIMENT CONTROL PRACTICES SHALL BE FUNCTIONAL PRIOR TO HYDROLOGIC DISTURBANCE OF THE SITE.
- 3. ALL DESIGN CRITERIA, SPECIFICATIONS, AND INSTALLATION OF EROSION AND SEDIMENT CONTROL

PRACTICES SHALL BE IN ACCORDANCE WITH THE ILLINOIS URBAN MANUAL.

- 4. A COPY OF THE APPROVED EROSION AND SEDIMENT CONTROL PLAN SHALL BE MAINTAINED ON THE
- 5. INSPECTIONS AND DOCUMENTATION SHALL BE PERFORMED, AT A MINIMUM:

 a) UPON COMPLETION OF INITIAL EROSION AND SEDIMENT CONTROL MEASURES, PRIOR TO ANY
 SOIL DISTURBANCE.

b) ONCE EVERY SEVEN (7) CALENDAR DAYS AND WITHIN 24 HOURS OF THE END OF A STORM EVENT

6. SOIL DISTURBANCE SHALL BE CONDUCTED IN SUCH A MANNER AS TO MINIMIZE EROSION.
IF STRIPPING, CLEARING, GRADING, OR LANDSCAPING ARE TO BE DONE IN PHASES, THE CO-PERMITTEE SHALL PLAN FOR APPROPRIATE SOIL EROSION AND SEDIMENT CONTROL MEASURES.

WITH GREATER THAN 0.5 INCH OF RAINFALL OR LIQUID EQUIVALENT PRECIPITATION.

- 7. A STABILIZED MAT OF CRUSHED STONE MEETING THE STANDARDS OF THE ILLINOIS URBAN MANUAL SHALL BE INSTALLED AT ANY POINT WHERE TRAFFIC WILL BE ENTERING OR LEAVING A CONSTRUCTION SITE. SEDIMENT OR SOIL REACHING AN IMPROVED PUBLIC RIGHT-OF-WAY, STREET, ALLEY OR PARKING AREA SHALL BE REMOVED BY SCRAPING OR STREET CLEANING AS ACCUMULATIONS WARRANT AND TRANSPORTED TO A CONTROLLED SEDIMENT DISPOSAL AREA.
- 8. CONCRETE WASHOUT FACILITIES SHALL BE CONSTRUCTED IN ACCORDANCE WITH THE ILLINOIS URBAN MANUAL AND SHALL BE INSTALLED PRIOR TO ANY ON SITE CONSTRUCTION ACTIVITIES INVOLVING CONCRETE.
- 9. MORTAR WASHOUT FACILITIES SHALL BE CONSTRUCTED IN ADDITION TO CONCRETE WASHOUT FACILITIES FOR ANY BRICK AND MORTAR BUILDING ENVELOPE CONSTRUCTION ACTIVITIES.
- 10. TEMPORARY DIVERSIONS SHALL BE CONSTRUCTED AS NECESSARY TO DIRECT ALL RUNOFF FROM HYDROLOGICALLY DISTURBED AREAS TO AN APPROPRIATE SEDIMENT TRAP OR BASIN. VOLUME CONTROL FACILITIES SHALL NOT BE USED AS TEMPORARY SEDIMENT BASINS.
- 11. DISTURBED AREAS OF THE SITE WHERE CONSTRUCTION ACTIVITIES HAVE TEMPORARILY OR PERMANENTLY CEASED SHALL BE STABILIZED WITH TEMPORARY OR PERMANENT MEASURES WITHIN SEVEN (7) DAYS.
- 12. ALL FLOOD PROTECTION AREAS AND VOLUME CONTROL FACILITIES SHALL, AT A MINIMUM, BE PROTECTED WITH A DOUBLE-ROW OF SILT FENCE (OR EQUIVALENT).
- 13. VOLUME CONTROL FACILITIES SHALL NOT BE CONSTRUCTED UNTIL ALL OF THE CONTRIBUTING
- 14. SOIL STOCKPILES SHALL, AT A MINIMUM, BE PROTECTED WITH PERIMETER SEDIMENT CONTROLS. SOIL STOCKPILES SHALL NOT BE PLACED IN FLOOD PROTECTION AREAS OR THEIR BUFFERS.
- 15. EARTHEN EMBANKMENT SIDE SLOPES SHALL BE STABILIZED WITH APPROPRIATE EROSION CONTROL
- 16. STORM SEWERS THAT ARE OR WILL BE FUNCTIONING DURING CONSTRUCTION SHALL BE PROTECTED
- BY APPROPRIATE SEDIMENT CONTROL MEASURES.

 17. THE CONTRACTOR SHALL EITHER REMOVE OR REPLACE ANY EXISTING DRAIN TILES AND INCORPORATE THEM INTO THE DRAINAGE PLAN FOR THE DEVELOPMENT. DRAIN TILES CANNOT BE TRIBUTARY TO A SANITARY OR COMBINED SEWER. DRAIN TILES ALLOWED IN COMBINED SEWER AREA FOR

GREEN INFRASTRUCTURE PRACTICES.

COMMENCEMENT OF DEWATERING ACTIVITIES.

PROTECTION AREAS OR THE COMBINED SEWER SYSTEM.

- 18. IF DEWATERING SERVICES ARE USED, ADJOINING PROPERTIES AND DISCHARGE LOCATIONS SHALL BE PROTECTED FROM EROSION AND SEDIMENTATION. DEWATERING SYSTEMS SHOULD BE INSPECTED DAILY DURING OPERATIONAL PERIODS. THE SITE INSPECTOR MUST BE PRESENT AT THE
- 19. THE CONTRCTOR SHALL BE RESPONSIBLE FOR TRENCH DEWATERING AND EXCAVATION FOR THE INSTALLATION OF SANITARY SEWERS, STORM SEWERS, WATERMAINS AS WELL AS THEIR SERVICES AND OTHER APPURTENANCES. ANY TRENCH DEWATERING, WHICH CONTAINS SEDIMENT SHALL PASS THROUGH A SEDIMENT SETTLING POND OR EQUALLY EFFECTIVE SEDIMENT CONTROL DEVICE. ALTERNATIVES MAY INCLUDE DEWATERING INTO A SUMP PIT, FILTER BAG OR EXISTING VEGETATED UPSLOPE AREA. SEDIMENT LADEN WATERS SHALL NOT BE DISCHARGE TO WATERWAYS, FLOOD
- 20. ALL PERMANENT EROSION CONTROL PRACTICES SHALL BE INITIATED WITHIN SEVEN (7) DAYS FOLLOWING THE COMPLETION OF SOIL DISTURBING ACTIVITIES.
- 21. ALL EROSION AND SEDIMENT CONTROL MEASURES SHALL BE MAINTAINED AND REPAIRED AS NEEDED ON A YEAR-ROUND BASIS DURING CONSTRUCTION AND ANY PERIODS OF CONSTRUCTION SHUTDOWN UNTIL PERMANENT STABILIZATION IS ACHIEVED.
- 22. ALL TEMPORARY EROSION AND SEDIMENT CONTROL MEASURES SHALL BE REMOVED WITHIN THIRTY (30) DAYS AFTER PERMANENT SITE STABILIZATION.
- 23. THE EROSION AND SEDIMENT CONTROL MEASURES SHOWN ON THE PLANS ARE THE MINIMUM REQUIREMENTS. ADDITIONAL MEASURES MAY BE REQUIRED, AS DIRECTED BY THE ENGINEER, SITE INSPECTOR, OR MWRD.

ERIKSSON ENGINEERING ASSOCIATES, LTD.

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EXPIRES: 04/30/2023

PROVEMENTS VENUE

EVERGREEN PARK

336 S. FORREST AVENUE

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Reserved for Seal:	
ENGINEE OF	Exp: 11/3

Date	Description
03/15/23	Issued For Permit
05/31/23	Revised For Village Permit

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Sheet Title:

MWRD GENERAL NOTES

Shoot No:

C-E002


TECHNICAL GUIDANCE MANUAL

MWRD GENERAL NOTES


TECHNICAL GUIDANCE MANUAL

STD. DWG. NO.18

PAGE NO. 19

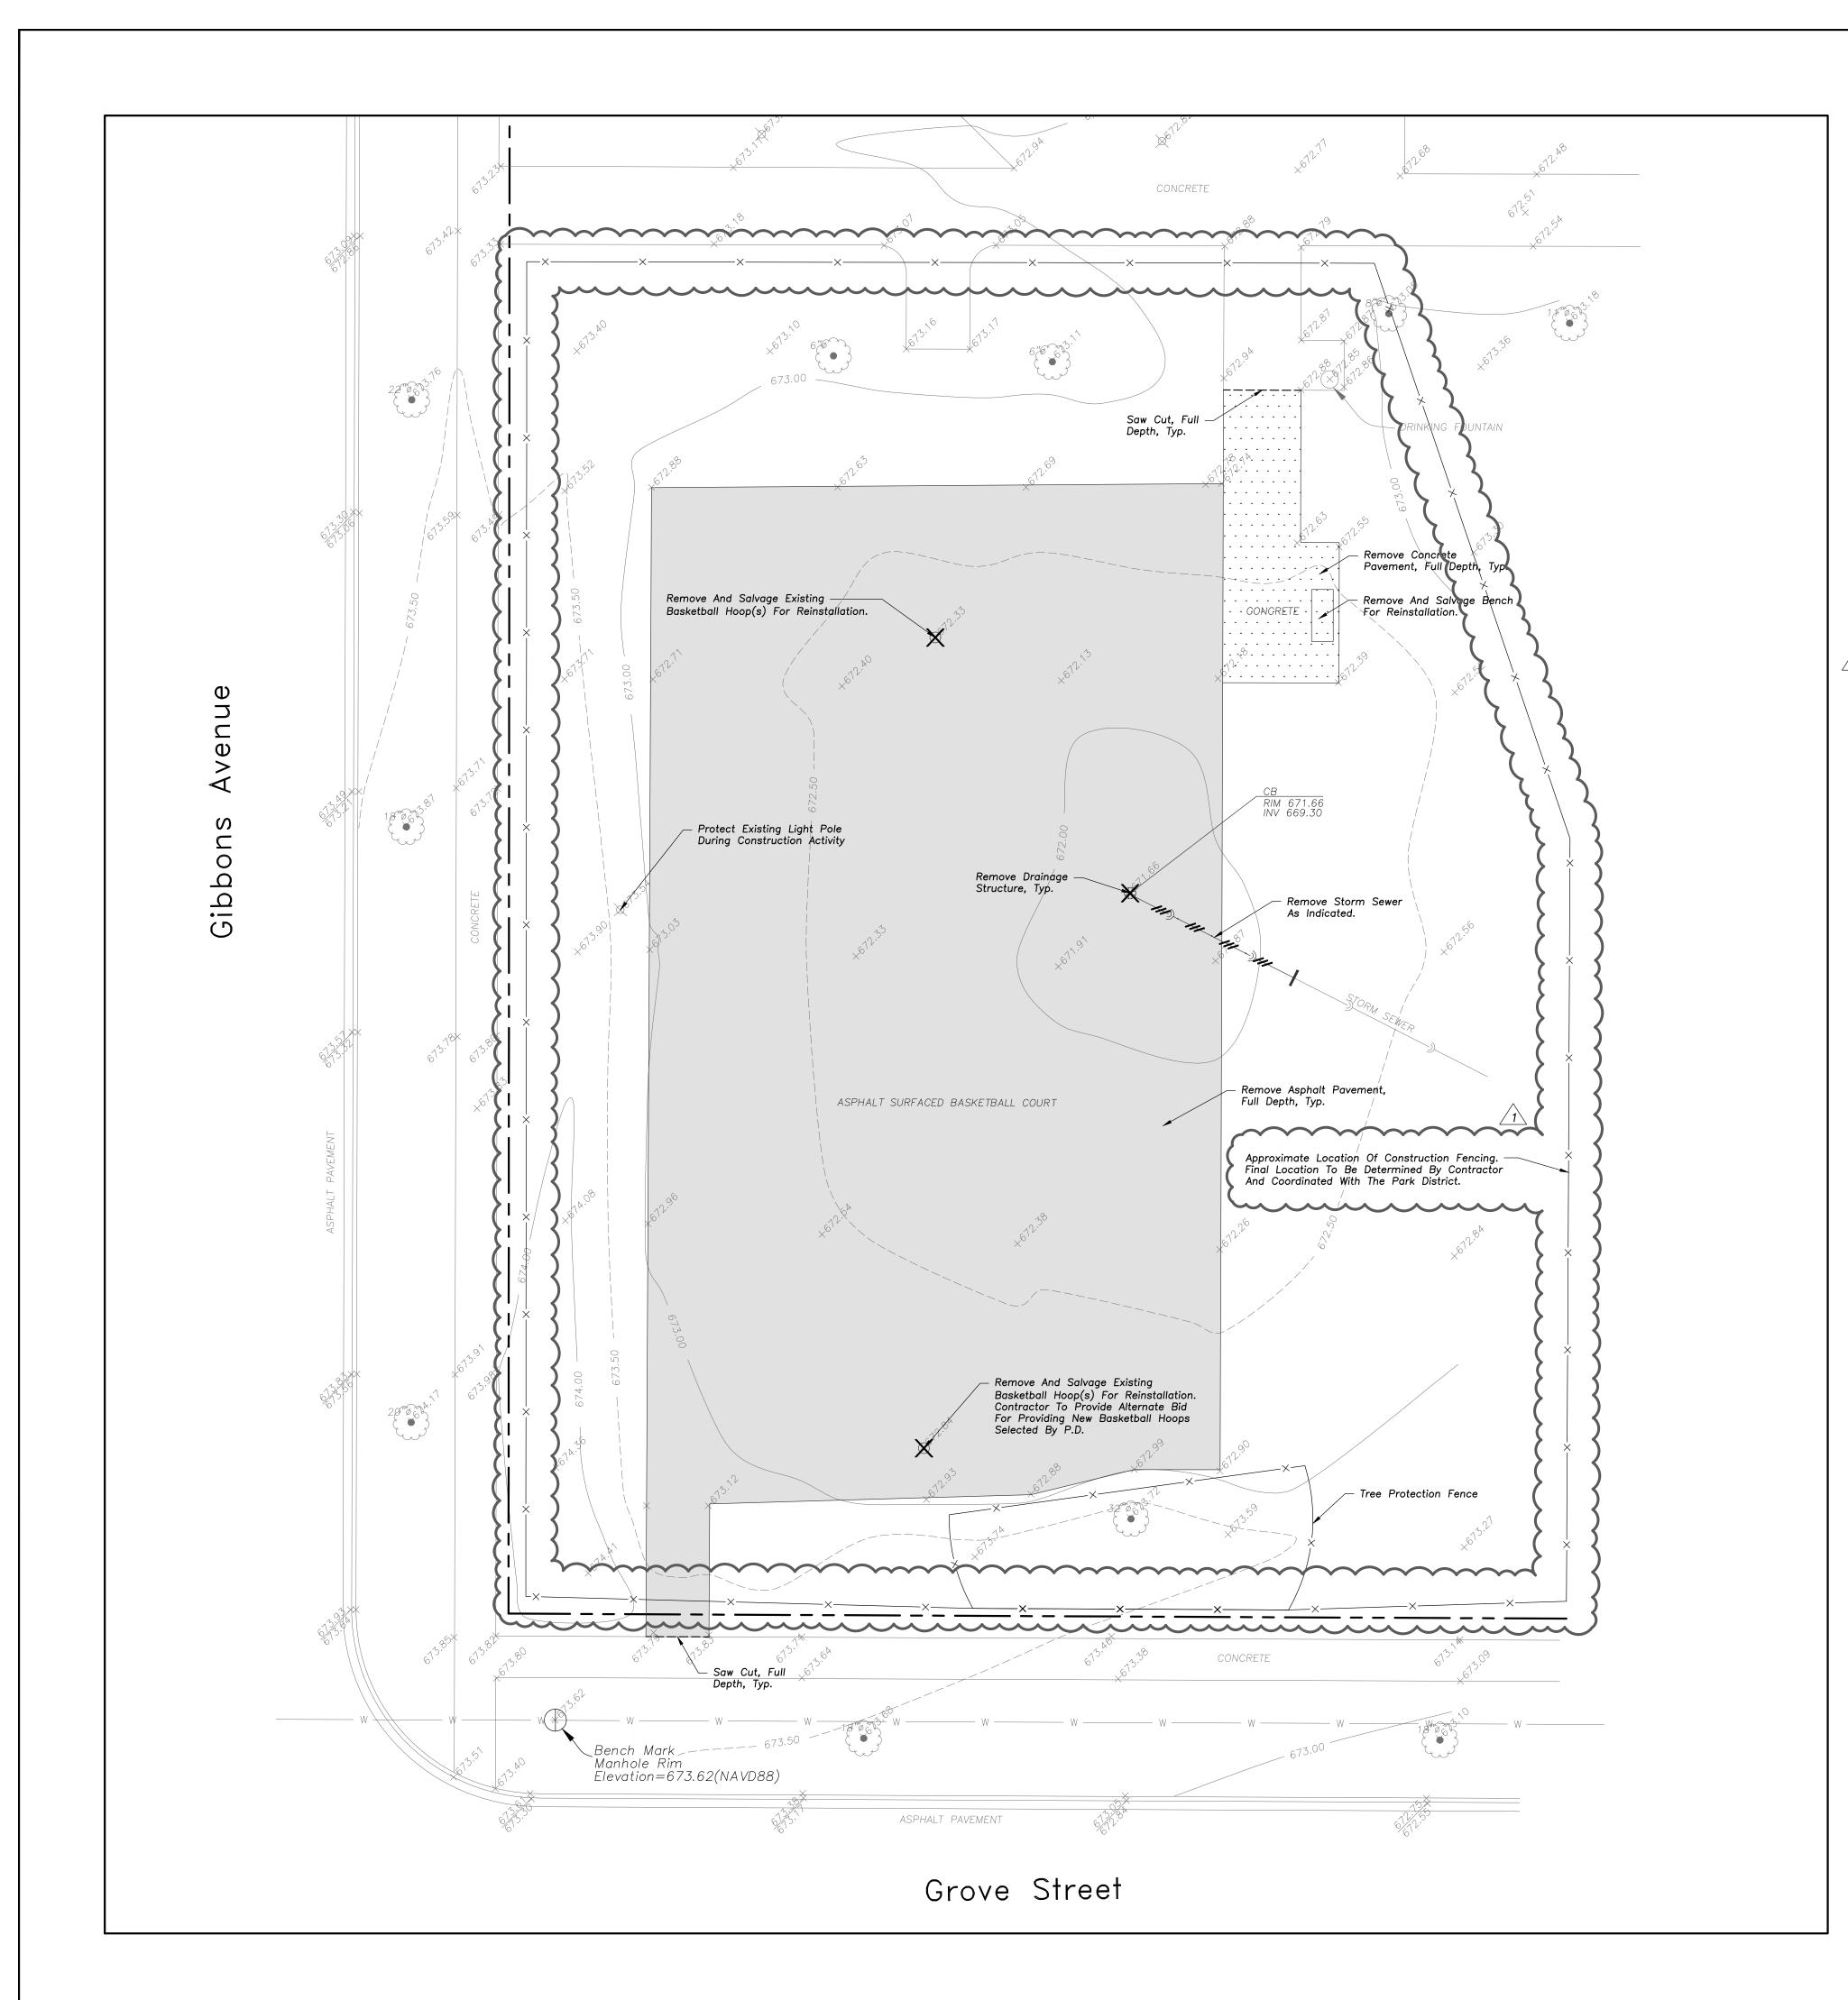




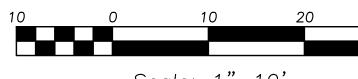

Scale: 1"=10

DEMOLITION LEGEND

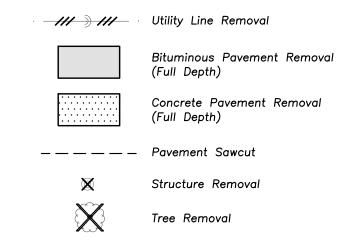

DEMOLITION NOTES

- Keep All Village Streets Free and Clear of Construction Related Dirt/Dust/Debris. Any Public Sidewalk That Is Damaged As A Result Of Construction Activity Shall Be Removed And Replaced At The Direction Of The Engineer Inspector.
- Construction Activity Shall Be Restored With Topsoil And Seed Or Sod And At The Direction Of The Engineer 4. Coordinate Existing Utility Removal with Local Authorities

Any Public Parkway That Is Damaged As A Result Of


- and Utility Companies Having Jurisdiction. 5. All Sawcutting Shall be Full Depth to Provide a Clean
- Edge to Match New Construction. Match Existing
 Elevations at Points of Connection for New and Existing Pavement, Curb, Sidewalks, etc. All Sawcut Locations Shown Are Approximate and May Be Field Adjusted to Accommodate Conditions, Joints, Material Type, etc. Remove Minimum Amount Necessary for Installation of Proposed Improvements.
- 6. Provide and Maintain All Necessary Traffic Control and Safety Measures Required During Demolition and Construction Operations Within or Near the Public
- 7. All Trees To Be Removed Shall Be Removed In Their Entirety and Stumps Shall Be Ground to Proposed Subgrade. Use As Mulch for Proposed Landscaping Where Applicable and Acceptable to Architect.

LEGEND

EXISTING		PROPOSED
	Catch Basin	•
O _{c.o.}	Clean Out	O _{c.o.}
	Storm Sewer	——) ——
	Sanitary Sewer	
W	Water Main	
——Е——	Electrical Cable (Buried)	——Е——
X	Light Pole	
-0-	Utility Pole	
d	Sign	
	Curb & Gutter	
	Depressed Curb	
× C 782.50	Curb Elevation	C 782.50
x G 782.00	Gutter Elevation	G 782.00
x P 783.25	Pavement Elevation	P 783.25
× W 782.10	Sidewalk Elevation	<u>W 782.10</u>
x 784.0	Ground Elevation	_x 784.0
• • • • • • • • • • • • • • • • • • • •	Swale	•••
	Contour Line	781
	Deciduous Tree	
	Coniferous Tree	
	Brushline	
	Tree Protection Fencing at Drip Line	x

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EXPIRES: 04/30/2023

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Reserved for Seal:
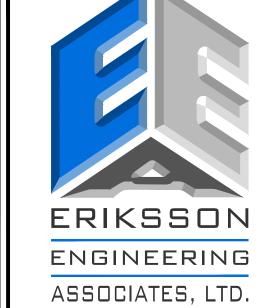
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		Exp: 11/30/23
No.	Date	Description
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1	05/31/23	Revised For Village Permit
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Sheet Title:

SITE DEMOLITION PLAN







Scale: 1"=10'

GEOMETRY NOTES

 All Dimensions Contained Herein Reference Back Of Curb, Face Of Retaining Wall, Edge Of Pavement, Center of Structure And Outside Face Of Building Foundation Unless Otherwise Noted.

LEGEND

EXISTING		PROPOSED
	Catch Basin	•
$\circ_{c.o.}$	Clean Out	O _{c.o.}
	Storm Sewer)
	Sanitary Sewer	
W	Water Main	
——E——	Electrical Cable (Buried)	——Е——
X	Light Pole	
-0-	Utility Pole	
d	Sign	
	Curb & Gutter	
	Depressed Curb	
x C 782.50	Curb Elevation	C 782.50
x G 782.00	Gutter Elevation	G 782.00
x P 783.25	Pavement Elevation	P 783.25
× W 782.10	Sidewalk Elevation	<i>W 782.10</i>
x 784.0	Ground Elevation	_x 784.0
* * * * * *	Swale	• • • • • • • • • • • • • • • • • • • •
	Contour Line	781
W (• 3	Deciduous Tree	
	Coniferous Tree	
	Brushline	
	Tree Protection Fencing at Drip Line	x

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HEIGHT


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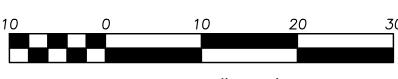
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Sheet Title:

SITE GEOMETRY PLAN





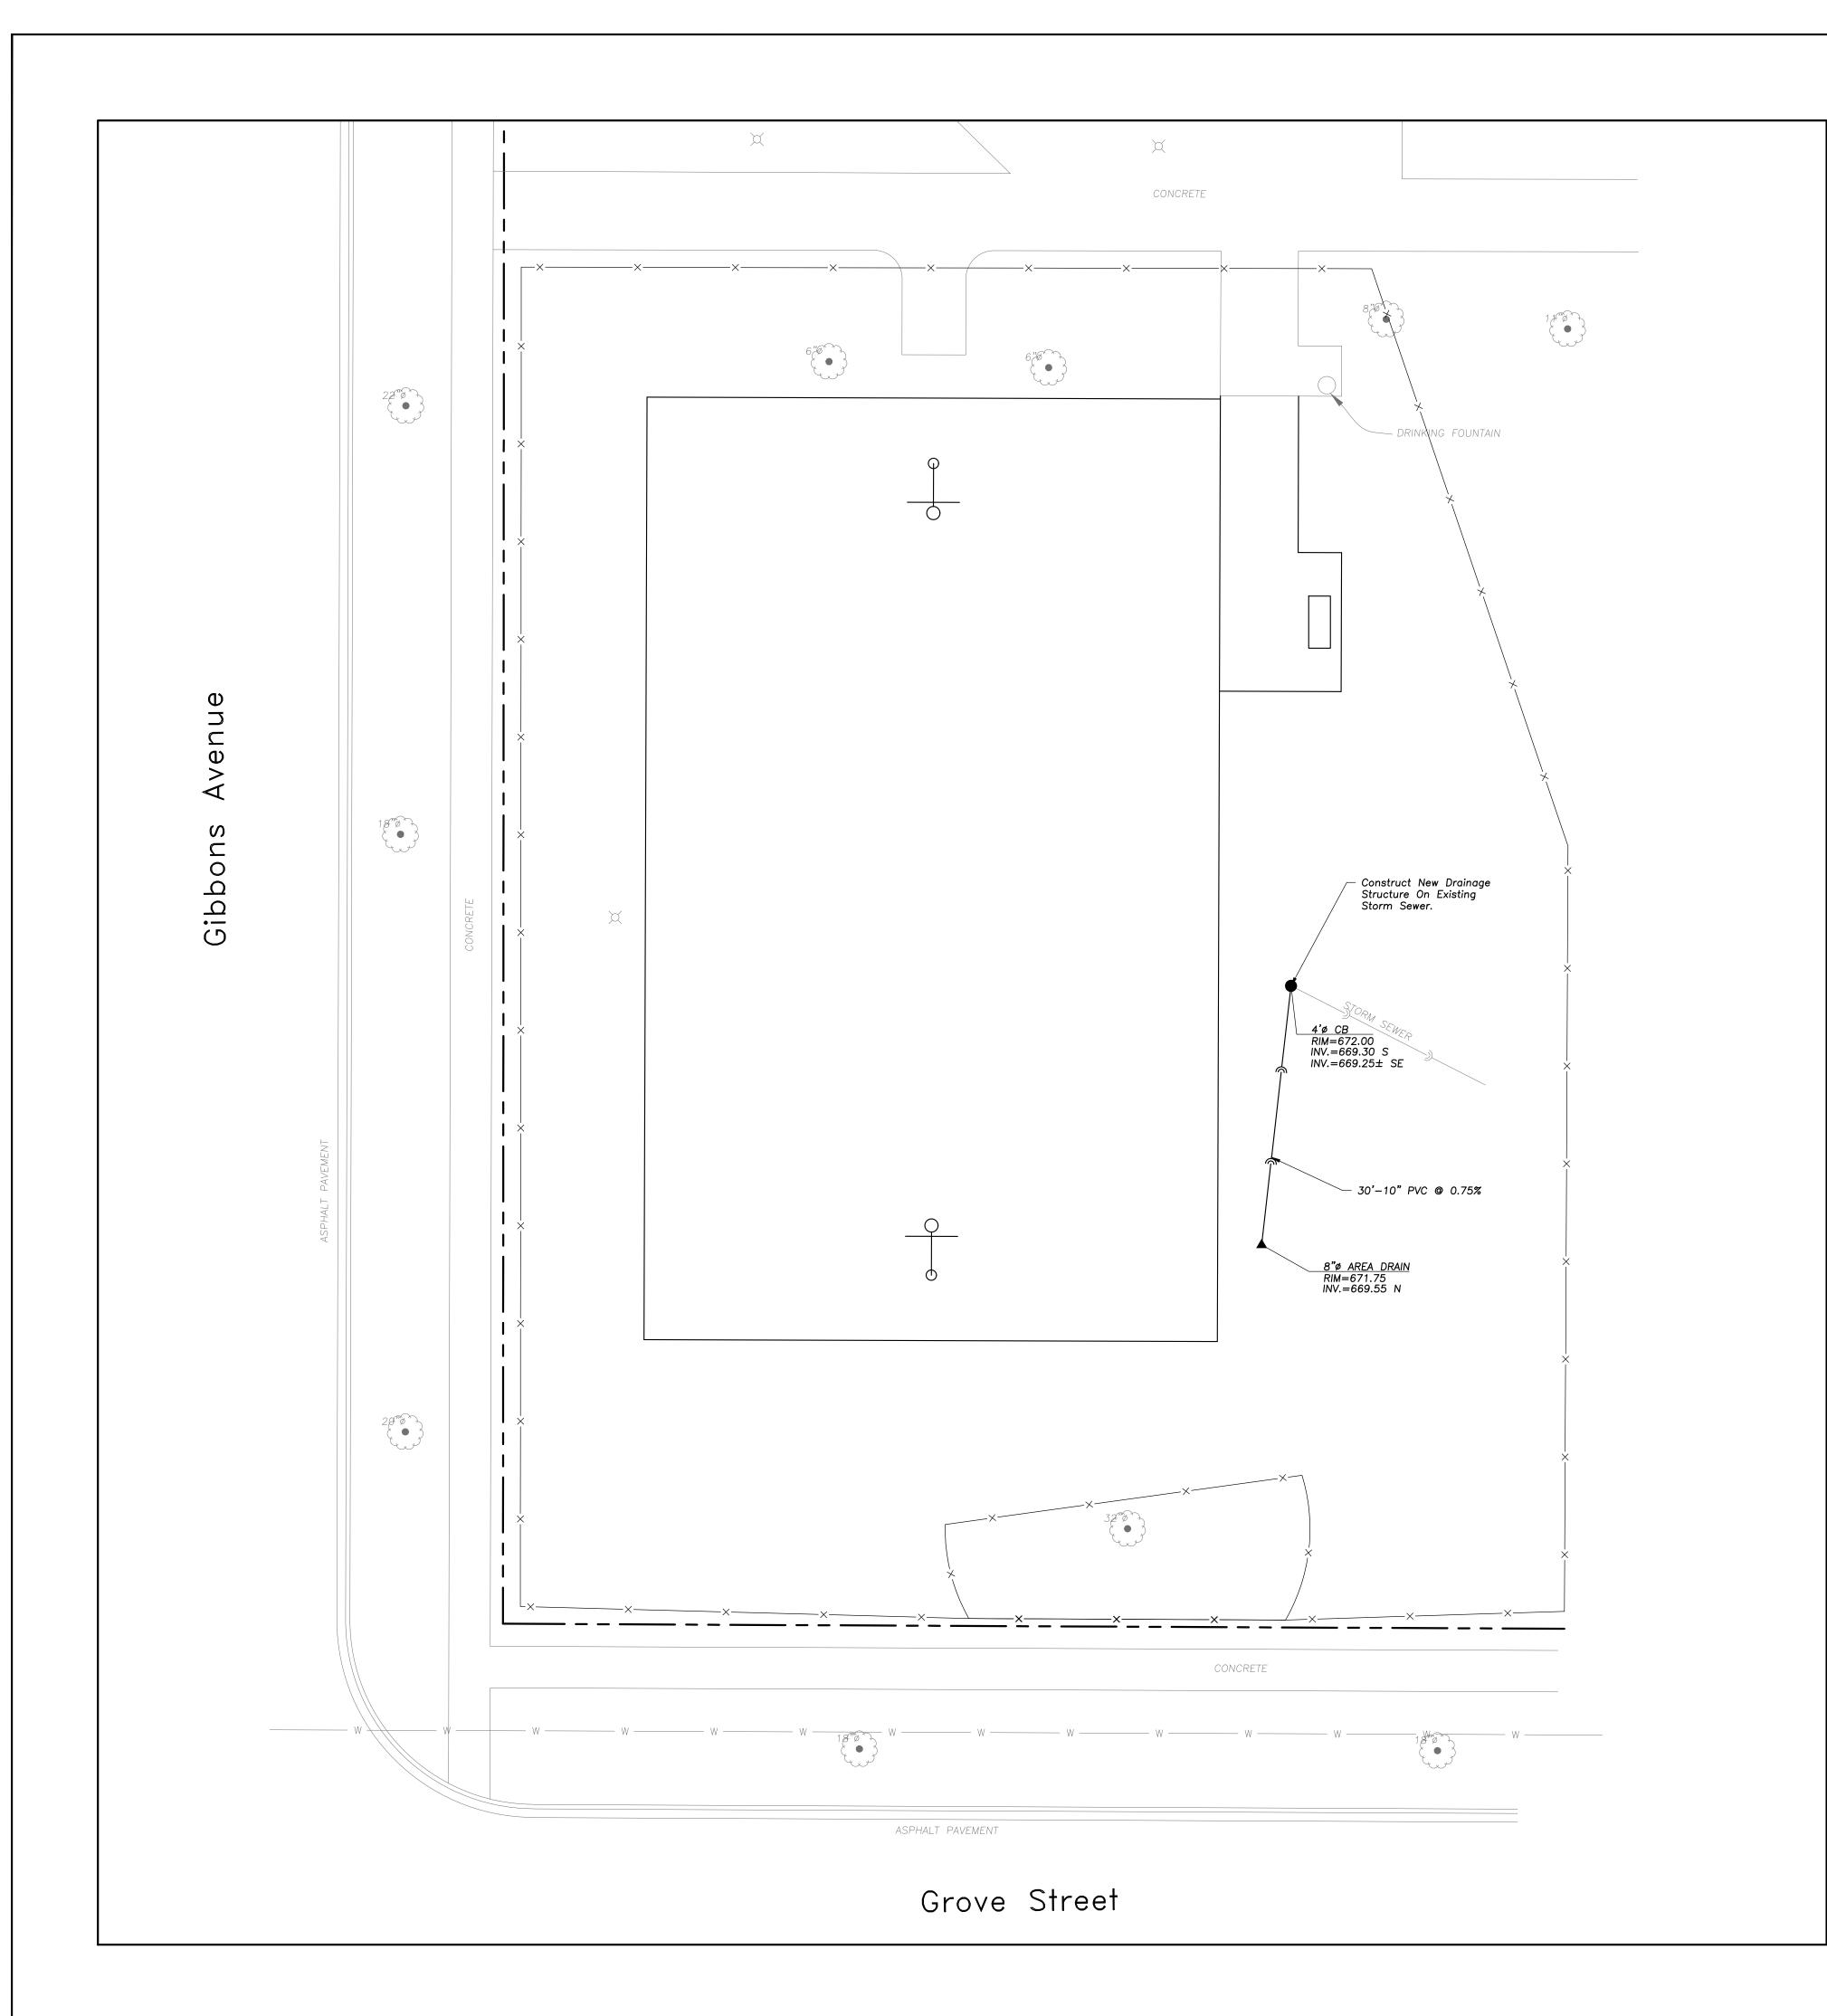

Scale: 1"=10'

UTILITY NOTES

- Utility Service Lines as Shown Hereon are Approximate. Coordinate The Exact Locations With The Plumbing Drawings. Coordinate The Locations With The Plumbing Contractor and/or the Owner's Construction Representative Prior to Installation of Any New Utilities.
- 2. Field Verify Invert & Locations of Existing Utility Mains Prior to Installing Any On-Site Utilities or Structures. All Elevations and Inverts Referencing Said Utility Shall Be Field Verified Prior To Installation Of Any New Structures Or Utilities, and Adjustments Shall Be Made as Necessary.
 Contact Engineer Prior to Installation if Discrepancy Exists
 With These Drawings.
- Coordinate the Relocation Of Any Utilities Encountered And Replacement Of Any Utilities Damaged Within Influence Zone Of New Construction. Contact Engineer If The Existing Utilities Vary Appreciably From The Plans.
- 4. Protection of water supplies shall be as described in Section 370.350 of the Illinois Recommended Standards for Sewage Works or Section 41-2.01 of the Standard Specifications for Water and Sewer Main Construction in Illinois, latest edition.
- 5. Clean Out All Existing and Proposed Storm Inlets and Catch Basins at the Completion of Construction.
- 6. The "Standard Specifications for Water and Sewer Main Construction in Illinois", Current Edition Shall Govern Work Where Applicable.

LEGEND

EXISTING		PROPOSED
	Catch Basin	•
O _{c.o.}	Clean Out	O _{c.o.}
	Storm Sewer	
	Sanitary Sewer	
W	Water Main	
——Е——	Electrical Cable (Buried)	——Е——
X	Light Pole	
-0-	Utility Pole	
o	Sign	
	Curb & Gutter	
	Depressed Curb	
× C 782.50	Curb Elevation	C 782.50
x G 782.00	Gutter Elevation	G 782.00
x P 783.25	Pavement Elevation	P 783.25
× W 782.10	Sidewalk Elevation	<u> W 782.10</u>
x 784.0	Ground Elevation	_x 784.0
* * • • • • • • • • • • • • • • • • • •	Swale	• • • • • • • • • • • • • • • • • • • •
	Contour Line	781
W (• 3	Deciduous Tree	
	Coniferous Tree	
*	Brushline	
	Tree Protection Fencing at Drip Line	x

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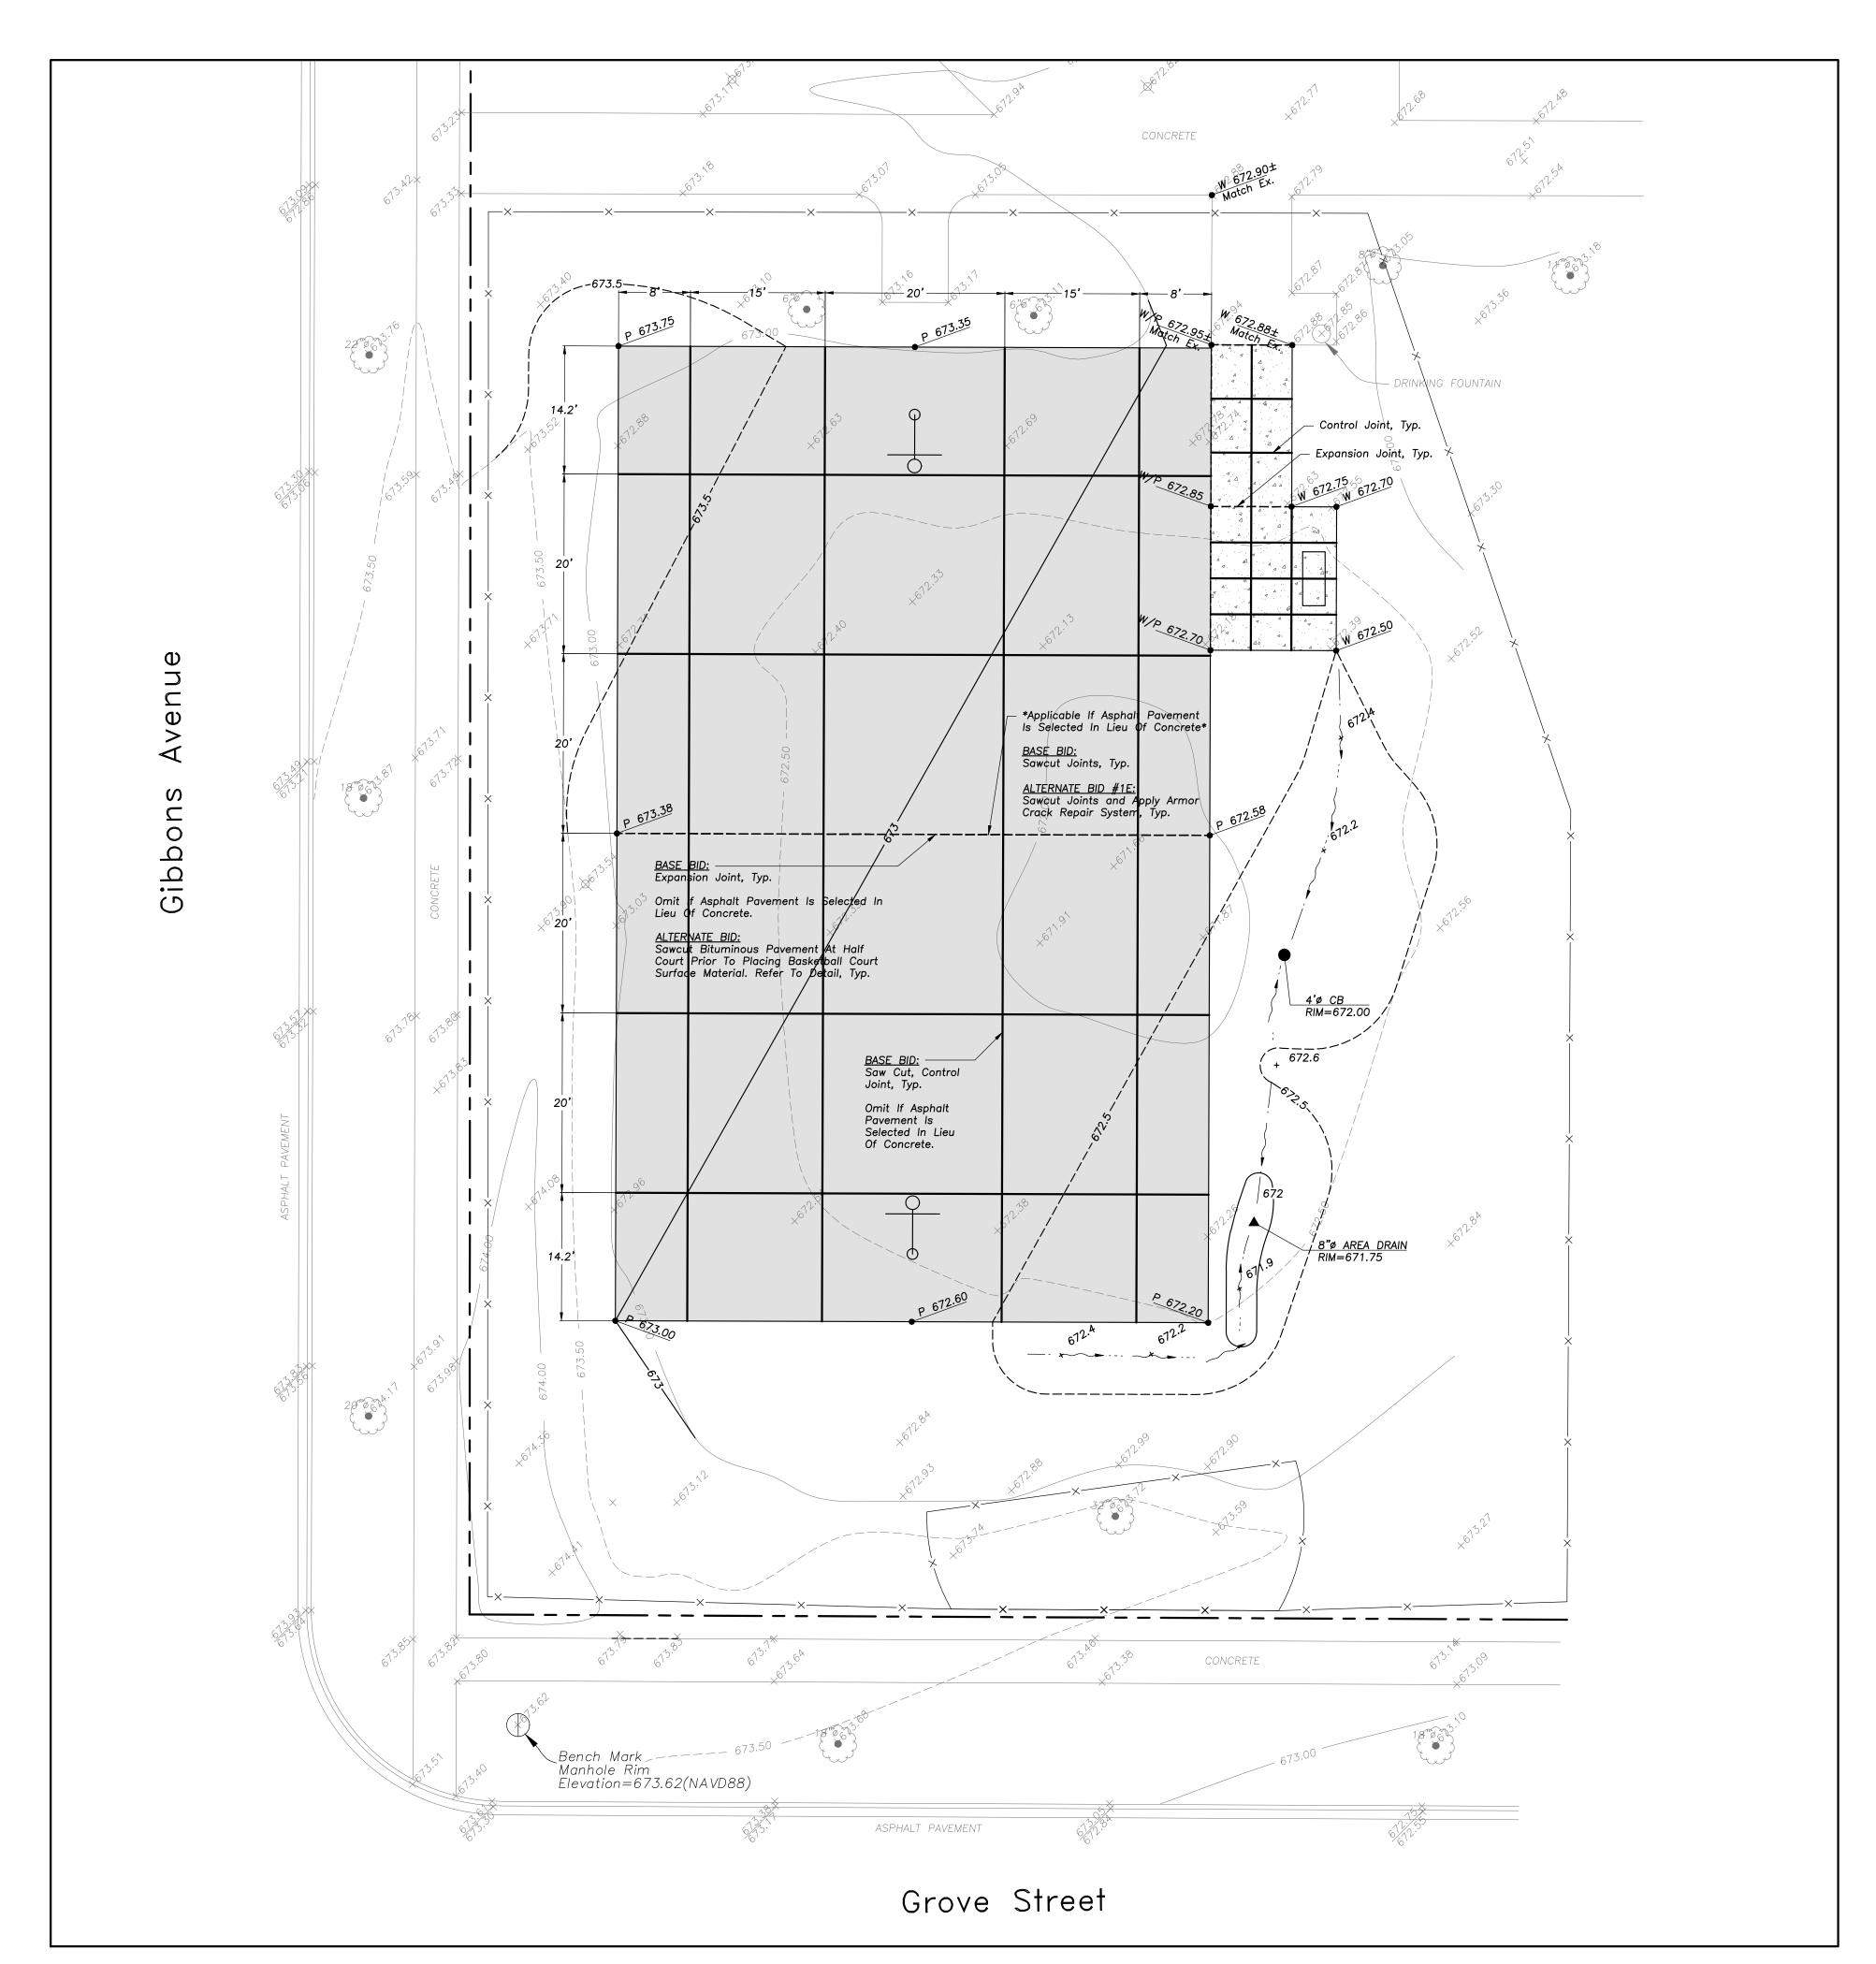
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02/17/23 JC

Sheet Title:

SITE UTILITY PLAN







Scale: 1"=10'

PAVING & SURFACE LEGEND

Basketball Court Pavement Section (NO RECYCLED MATERIAL ALLOWED) Surface Coating

(Elite Sport Coating System Or Approved Equal) Inner Court Color: Dark Blue (Or Approved Équal) Outer Court Color: Light Green (Or Approved Equal)

BASE BID 5" Portland Cement Concrete Pavement

No. 4 Reinforcing Bars 24" O.C In Both Directions 4" Aggregate Base Course, Type B, Crushed

ALTERNATE 1 1 1/2" Hot Mix Asphalt, IL-9.5, N30, PG58-28 (Virgin Mix, NO RAP, RAS, FRAP)

Tack Coat (0.25 gal/sq yd)
Tensar GlasPave GP25 Waterproofing Paving Mat (Or Approved Equal) 2 1/2" Hot Mix Asphalt, IL-19.0, N50, PG58-28 (Virgin Mix, NO RAP, RAS, FRAP) Prime Coat (0.25 gal/sq yd)

8" Aggregate Base Course, Type B, Crushed (Minimum) Include Tensar Geogrid TX160 At Bottom Of Base Course

Concrete Sidewalk Section 5" Portland Cement Concrete 6"x6" W1.+xW1.4 Welded Wire Fabric 4" Aggregate Base Course, Type B, Crushed

In Selected Pavement Section

(Installed Per Manufacturers Specifications)

GRADING NOTES

- 1. The Grading and Construction of Proposed Improvements Shall Be Done In A Manner Which Will Allow For Positive Drainage, and Not Cause Ponding of Stormwater on the Surface of Proposed Improvements.
- 2. All Landscaped Areas Disturbed By Construction Shall Be Respread With 6 Inches (Min.) to 12 Inches (Max.) Topsoil and **Hydroseeded** Unless Noted Otherwise On The Landscape Drawings.

LEGEND

EXISTING		PROPOSED
	Catch Basin	•
O _{c.o.}	Clean Out	O _{c.o.}
——)——	Storm Sewer	——) ——
	Sanitary Sewer	
W	Water Main	
——— E ———	Electrical Cable (Buried)	——Е——
X	Light Pole	
-0-	Utility Pole	
d	Sign	
	Curb & Gutter	
	Depressed Curb	
× C 782.50	Curb Elevation	C 782.50
x G 782.00	Gutter Elevation	G 782.00
x P 783.25	Pavement Elevation	<u>P 783.25</u>
× W 782.10	Sidewalk Elevation	<u> W 782.10</u>
x 784.0	Ground Elevation	_x 784.0
* * • * * * *	Swale	
	Contour Line	781
M (• 3	Deciduous Tree	
W W	Coniferous Tree	
	Brushline	
	Tree Protection Fencing at Drip Line	x

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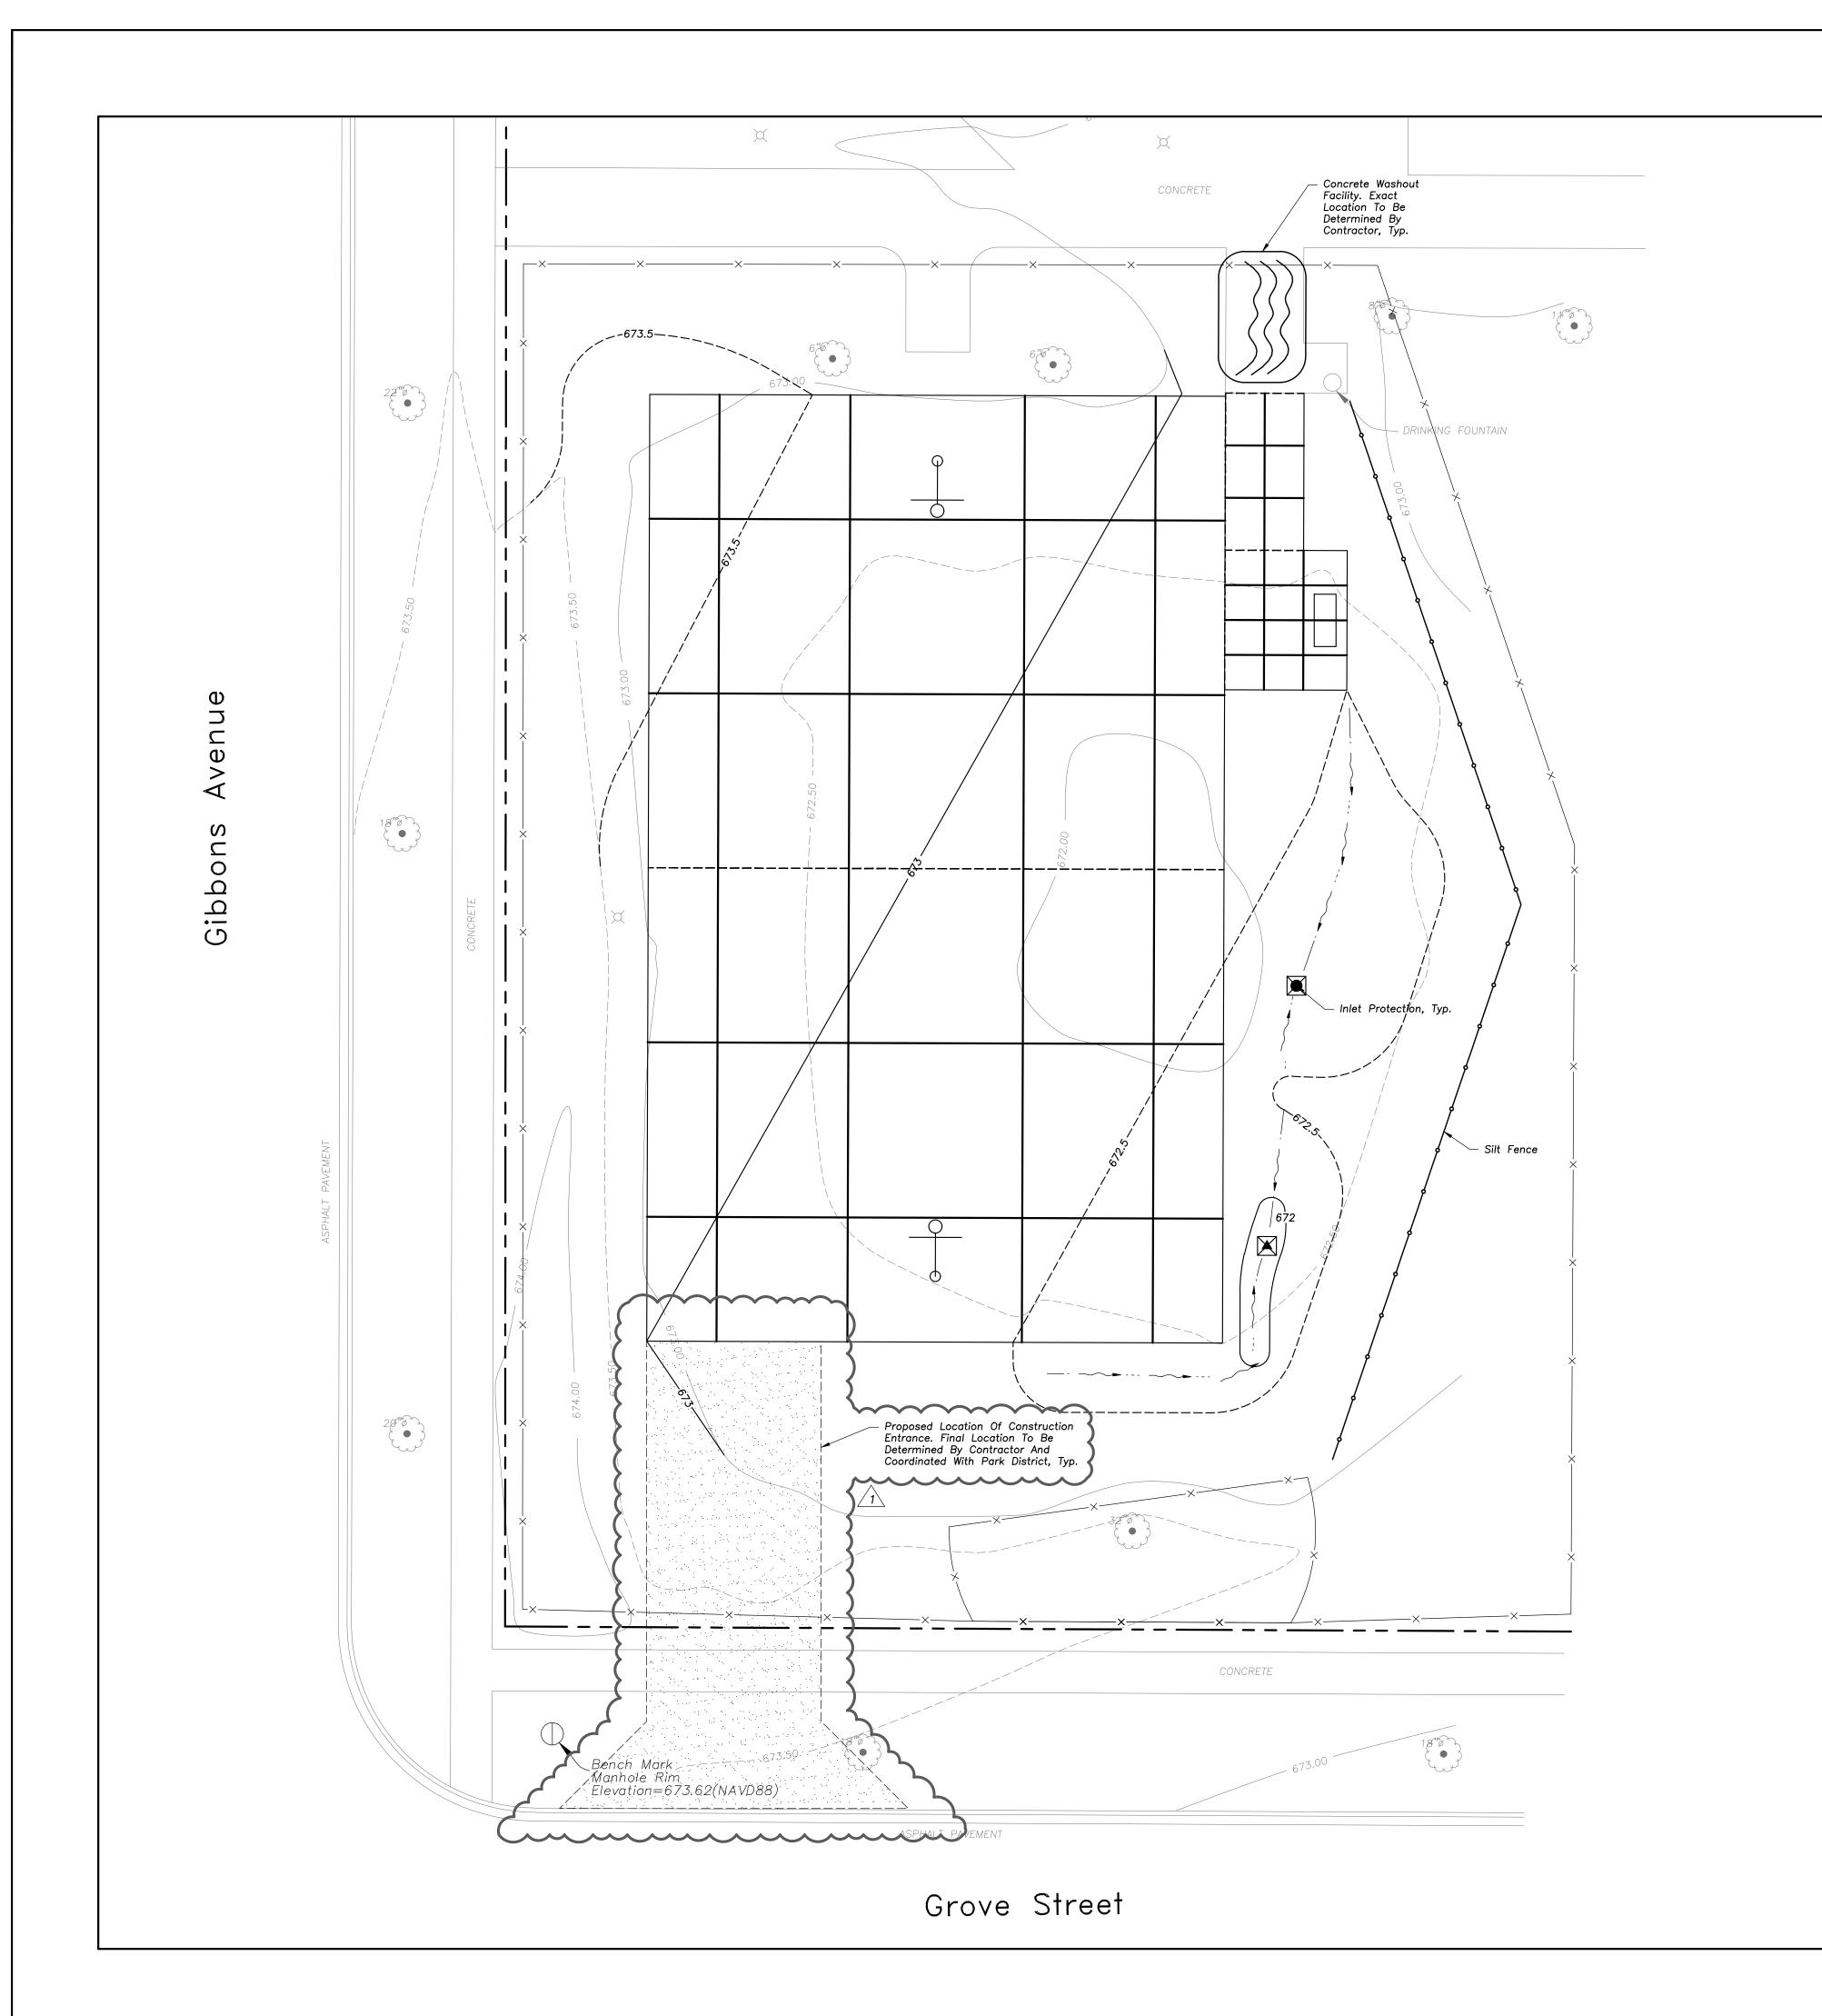
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Sheet Title:

GRADING AND PAVING PLAN







SOIL EROSION & SEDIMENTATION CONTROL

Silt Fence

LEGEND

Catch-All, Pork Chop Sediguard (or equal) Paved or Existing Stabilized

SOIL EROSION & SEDIMENTATION CONTROL NOTES

- 1. Illinois Urban Manual Shall Govern All Soil Erosion and Sediment Control, and Related Work.
- 2. Soil Disturbance Shall Be Conducted in Such a Manner as To Minimize Erosion, Soil Stabilization Measures Shall Consider the Time of Year, Site Conditions, and the Use of Temporary or Permanent Measures.
- 3. Soil Erosion and Sediment Control Features Shall Be Constructed Prior to the Commencement of Upland
- 4. Temporary Soil Stabilization Shall Be Applied to Topsoil Stockpiles and Disturbed Areas, Where Construction Activity Will Not Occur For A Period of More Than 14 Calendar Days, Temporary Measures Shall Be Applied Within 7 Calendar Days of the End of Active Hydrologic Disturbance. The Sediment Control Measures Shall Be Maintained On A Continuing Basis Until The Site Is Permanently Stabilized And All Inspections Are Complete. Permanent Stabilization Shall Be Completed Within 14 Days after Completion of Final Grading of Soil.
- 5. All Temporary And Permanent Erosion Control Measures Shall Be Removed Within 30 Days After Final Site Stabilization Is Achieved Or After The Temporary Measures Are No Longer Needed. Trapped Sediment And Other Disturbed Soil Areas Shall Be Permanently Stabilized.
- 6. Final Site Stabilization Is Defined By The EPA General Permit As Meaning That All Soil Disturbing Activities At The Site Have Been Completed, And That A Uniform Perennial Vegetative Cover With A Density Of 70 Percent Of The Cover For Unpaved Areas Not Covered By Permanent Structures Has Been Established Or Equivalent Permanent Stabilization Measures (Such As The Use Of Riprap, Gabions, Or Geotextiles) Have Been Employed.
- 7. All Storm Sewer Structures That Are, Or Will Be, Functioning During Construction Shall Be Protected, Filtered, Or Otherwise Treated To Remove Sediment. The General Contractor Shall Use "Catch-All" Inlet Protectors (or equal) and Filter Wattles Around The Grate In Landscaped Areas And "Catch-All" Inlet Protectors (or equal) In Paved Areas To Prevent Siltation.
- 8. All Temporary And Permanent Sediment And Erosion Control Measures Must Be Maintained, Repaired, And Inspected In Conformance With All Applicable IEPA-NPDES
- 9. Following The Termination Of Construction Activities And Issuance Of The Required "Notice Of Termination". The Permittees Must Keep A Copy Of The Storm Water Pollution Prevention Plan, Inspection Reports, And Records Of All The Data Used To Complete The Notice Of Intent For A Period Of At Least Three Years Following Final
- 10. Install And Maintain Silt Fence At The Perimeter Of The Construction Zone And Wetland Areas And As Shown On The Plans. Maintain Silt Fence Throughout Construction And Until Vegetation Has Been Fully Established.
- 11. Contractor Shall Provide Qualified Soil Erosion and Sediment Control Inspector Services in Accordance with NPDES and Governmental Requirements. Inspections Shall Occur at Every Seven Calendar Days Or Within 24 Hours of a 0.5" or Greater Rainfall Event. Engineer Shall Be Copied on Inspection Logs.
- 12. The Erosion Control Measures Indicated On The Drawings Are The Minimum Requirements. Additional Measures May Be Required As Directed By The Qualified Soil and Erosion Sediment and Control Inspector Or Governing Agency.
- Hazardous Materials If They Occur In Accordance with IEPA NPDES Requirements. 14. All Concrete Washout Shall Conform To The "Temporary

Concrete Washout Facility" Standards (Code 954) of the

13. Report Releases of Reportable Quantities of Oil or

- Illinois Urban Manual, Latest Edition. 15. If Necessary, The SWPPP Shall Be Modified To Reflect Changes Required During The Effective Period Of The IEPA NPDES General Permit No ILR10 and Local and County
- 16. Dewatering of Excavations Shall be Performed in a Manner Such as Through the use of Filter Bags or Polymer Treated Dewatering Swales, so as to Not Discharge Sediment Laden Water Into Storm Sewers Tributary to Open Water.



EXISTING

PROPOSED

LEGEND

	0.4.4.5.	
	Catch Basin	
$\circ_{\text{c.o.}}$	Clean Out	O _{c.o.}
	Storm Sewer	
	Sanitary Sewer	
W	Water Main	
——Е——	Electrical Cable (Buried)	——Е——
X	Light Pole	
	Utility Pole	
d	Sign	
	Curb & Gutter	
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781	Contour Line	781
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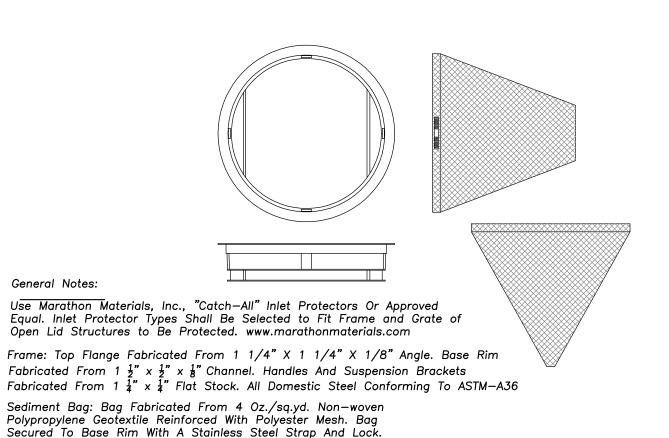
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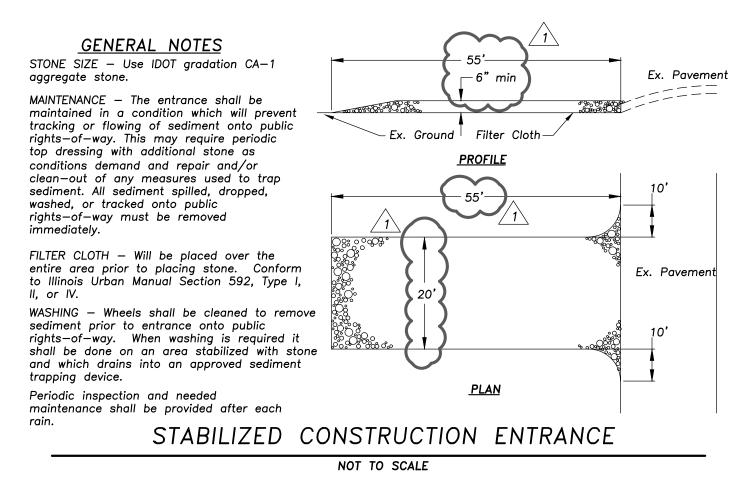
SITE EROSION AND SEDIMENT **CONTROL PLAN**




Install Baskets In All Existing Storm Inlets Prior To Construction And All New Storm Inlets Immediately After Installation. Contractor Shall Maintain Throughout Construction Activities.


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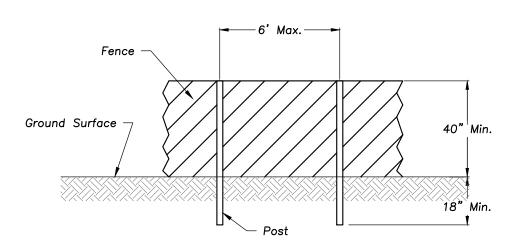
INLET PROTECTORS — SEDIMENT BAG



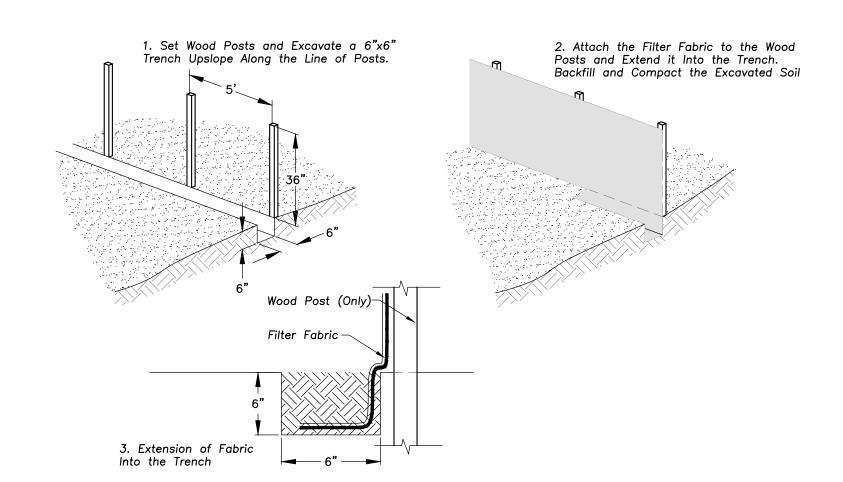

SILT FENCE CONSTRUCTION (AASHTO 288-00)




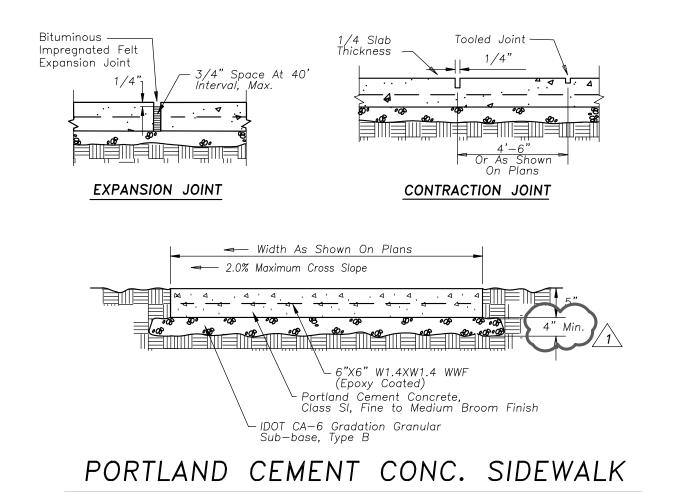

POST AND FENCE DETAIL


1. The fence shall be located a minimum of 1 foot outside the drip line of the tree to be saved and in no case closer than 5 feet to the trunk of any tree. 2. Fence posts shall be either standard steel posts or wood posts with a minimum cross sectional area of 3.0 sq. in.
3. The fence may be either 40" high snow fence, 40" plastic web fencing or any other material as approved by the engineer/inspector.

TREE PROTECTION FENCE

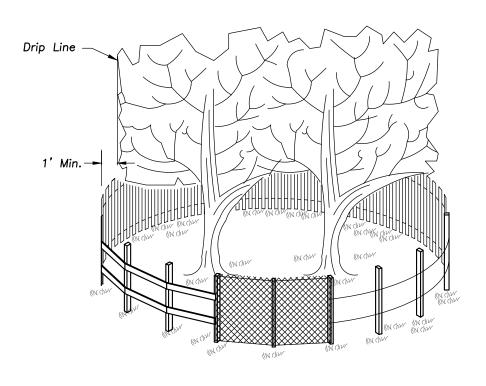


SIDE VIEW


TREE PROTECTION FENCE

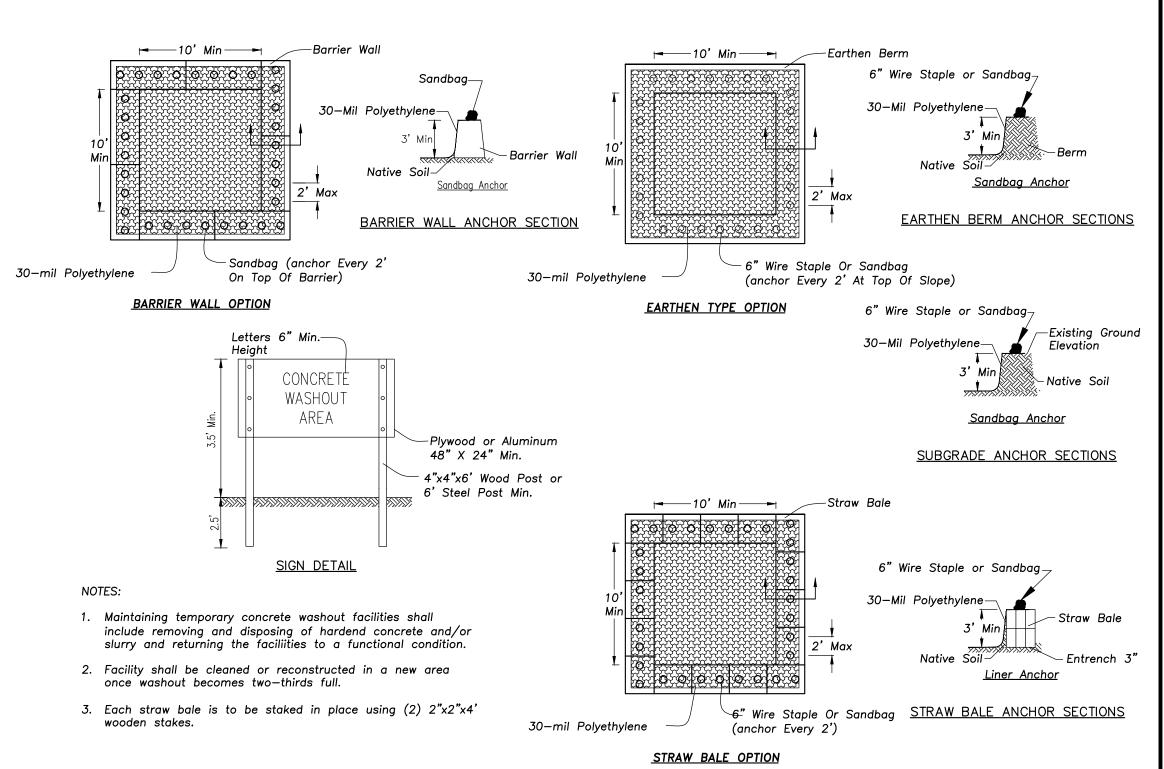

CONCRETE WASHOUT FACILITY

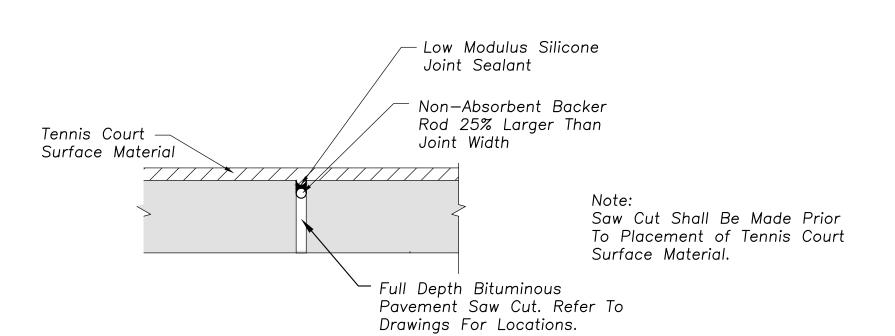

BASE BID: TENNIS COURT SAWCUT JOINT DETAIL

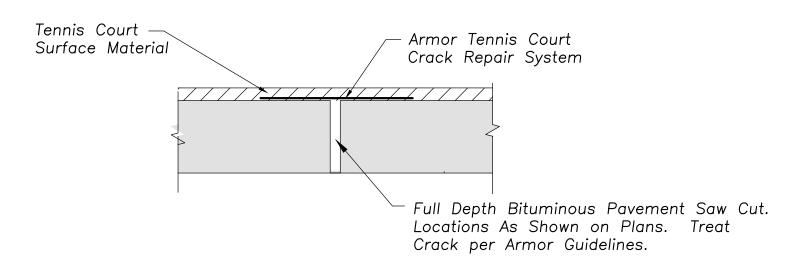

ALTERNATE BID #1H: TENNIS COURT SAWCUT JOINT WITH ARMOUR CRACK REPAIR DETAIL



145 COMMERCE DRIVE, SUITE A GRAYSLAKE, ILLINOIS 60030 PHONE (847) 223-4804 FAX (847) 223-4864 EMAIL INFO@EEA-LTD.COM PROFESSIONAL DESIGN FIRM LICENSE No. 184-003220 EXPIRES: 04/30/2023

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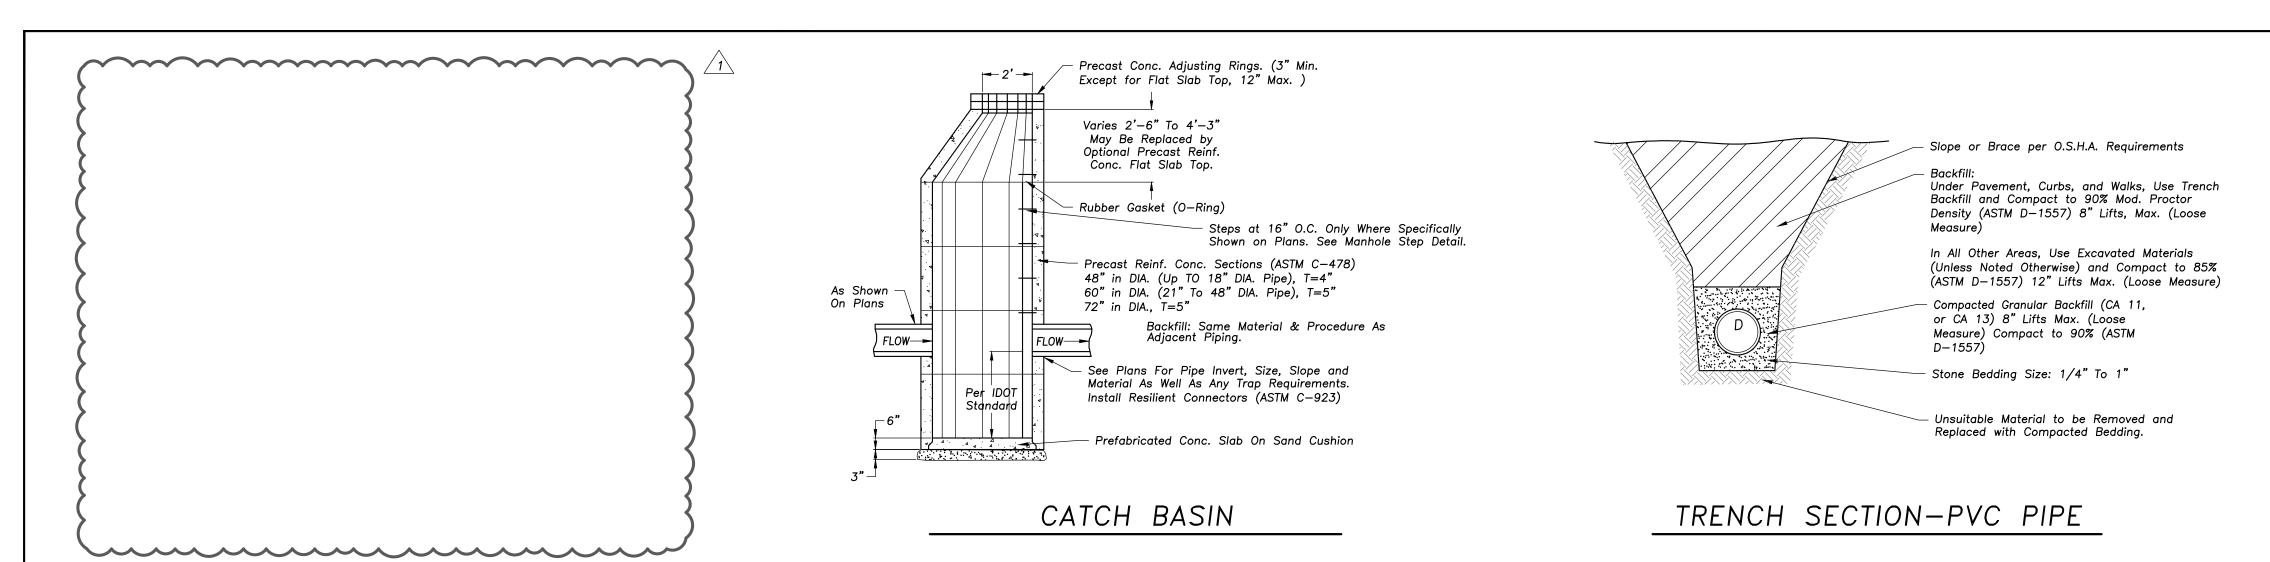
ENUE RECREA



		Exp: 11/30/23
No.	Date	Description
	03/15/23	Issued For Permit
1	05/31/23	Revised For Village Permit
⊚ FB	IKSSON ENGIN	JEERING ASSOCIATES, LTD., 2023

Approved By: Date: JC 02/17/23

SITE WORK **DETAILS**



Section 2722

Engineered Surface Drainage Products

GENERALPVC surface drainage inlets shall be of the inline drain type as indicated on the contract drawing and referenced within the contract specifications. The ductile iron grates for each of these fittings are to be considered an integral part of the surface drainage inlet and shall be furnished by the same manufacturer. The surface drainage inlets shall be as manufactured by Nyloplast a division of Advanced Drainage Systems, Inc., or prior approved equal.

MATERIALS


The inline drain required for this contract shall be manufactured from PVC pipe stock, utilizing a thermo-molding process to reform the pipe stock to the furnished configuration. The drainage pipe connection stubs shall be manufactured from PVC pipe stock and formed to provide a watertight connection with the specified pipe system. This joint tightness shall conform to <u>ASTM D3212 for joints for drain and sewer plastic pipe using flexible elastomeric seals</u>. The flexible elastomeric seals shall conform to <u>ASTM F477</u>. The pipe bell spigot shall be joined to the inline drain body by use of a **swage mechanical joint**. The raw material used to manufacture the pipe stock that is used to manufacture the inline drain body and pipe stubs of the surface drainage inlets shall conform to <u>ASTM D1784 cell class</u> 12454.


The grates furnished for all surface drainage inlets shall be ductile iron grates for sizes 8", 10", 12", 15", 18", 24" and 30" shall be made specifically for each fitting so as to provide a round bottom flange that closely matches the diameter of the surface drainage inlet. Grates for inline drains shall be capable of supporting H-20 wheel loading for traffic areas or H-10 loading for pedestrian areas. 12" and 15" square grates will be hinged to the frame using pins. Metal used in the manufacture of the castings shall conform to ASTM A536 grade 70-50-05 for ductile iron. Grates shall be provided painted black.

INSTALLATION

The specified PVC surface drainage inlet shall be installed using conventional flexible pipe backfill materials and procedures. The backfill material shall be crushed stone or other granular material meeting the requirements of class 1, class 2, or class 3 material as defined in <u>ASTM D2321</u>. Bedding and backfill for surface drainage inlets shall be well placed and compacted uniformly in accordance with <u>ASTM D2321</u>. The drain basin body will be cut at the time of the final grade. No brick, stone or concrete block will be required to set the grate to the final grade height. For H-20 load rated installations, a concrete ring will be poured under and around the grate and frame. The concrete slab must be designed taking into consideration local soil conditions, traffic loading, and other applicable design factors. For other installation considerations such as migration of fines, ground water, and soft foundations refer to <u>ASTM D2321</u> guidelines.

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IS FORBIDDEN, EXCEPT BY SPECIFIC WRITTEN										
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PHONE (847) 223-4804
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EMAIL INFO@EEA-LTD.COM
PROFESSIONAL DESIGN FIRM
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EXPIRES: 04/30/2023

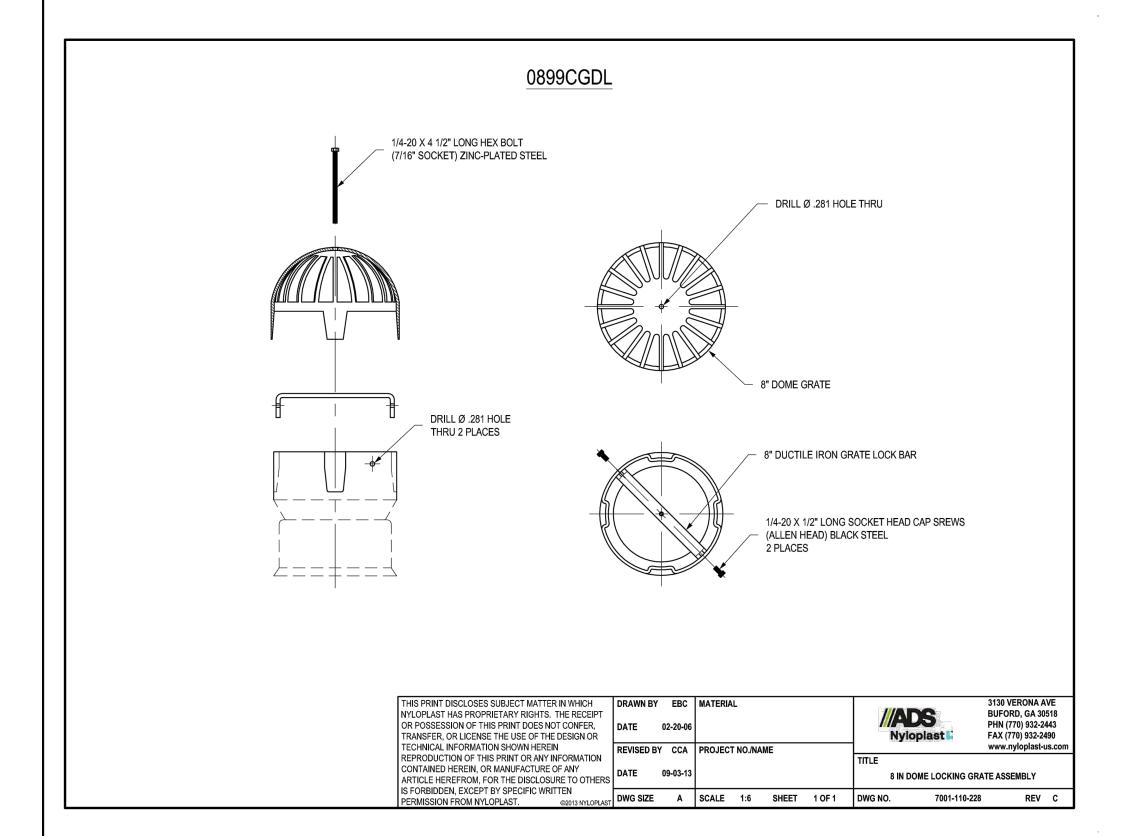
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R X SEATION COURT IMPROVEME

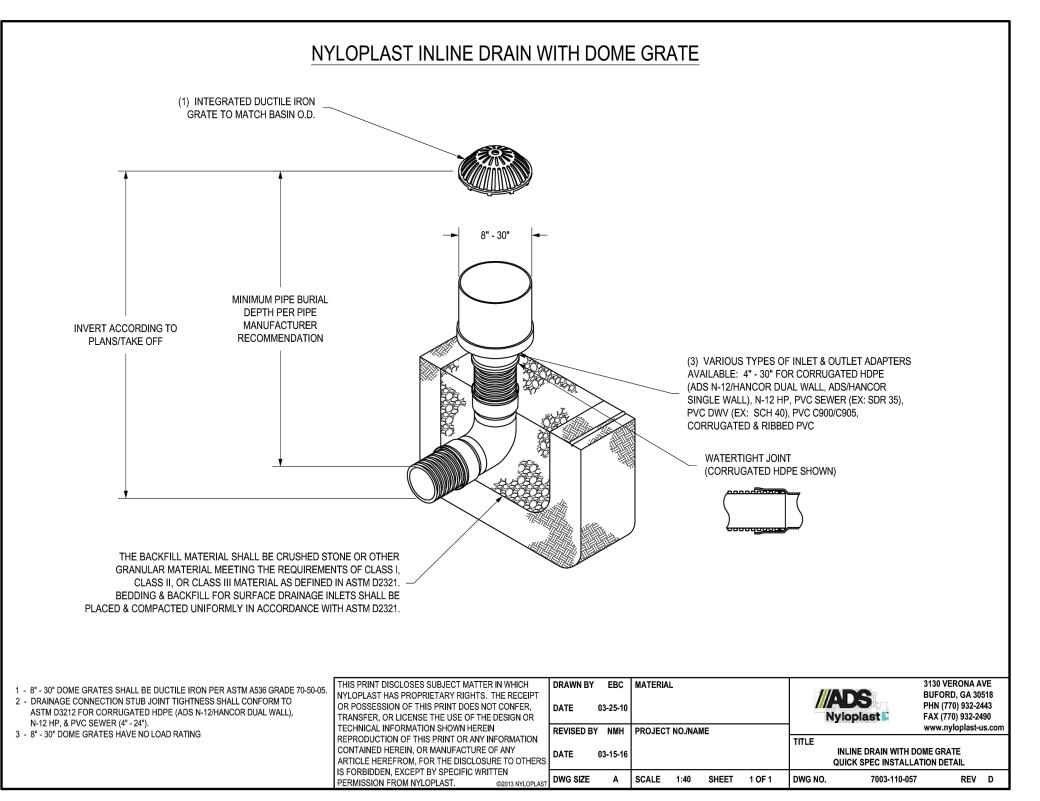EVERGREEN PARK

336 S. FORREST AVENUE

ARINGTON HEIGHTS IN INCIR.

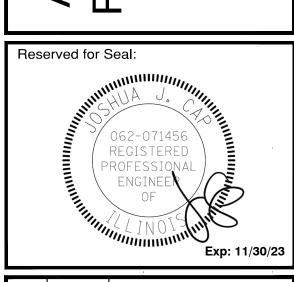

		Exp: 11/30/23
No.	Date	Description
	03/15/23	Issued For Permit
1	05/31/23	Revised For Village Permit
		IEEDING ASSOCIATES LTD 2022

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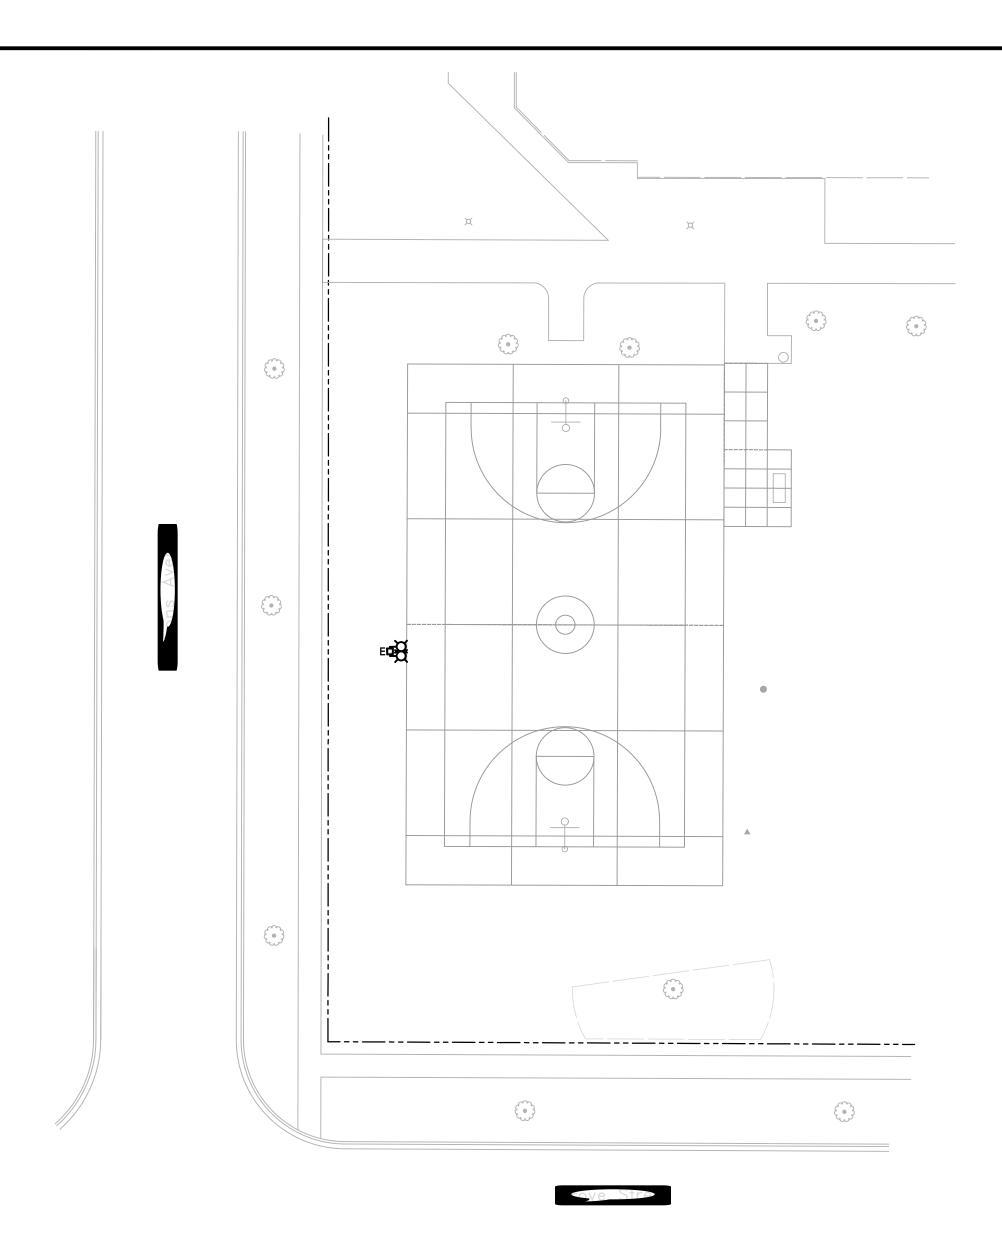
Design By: Approved By: Date:

NH JC 02/17/23

Sheet Title:

SITE WORK DETAILS

Sheet No:





NOTES:

- E.C. TO REUSE EXISTING LIGHTING CIRCUIT AND LIGHTING CONTROL CURRENTLY FEEDING EXISTING LIGHTING.
- E.C. TO PROVIDE NEW POLE AND LUMINAIRES. E.C. TO MATCH EXISTING POLE HEIGHT AND COLOR. PROVIDE NEW CONCRETE BASE IF REQUIRED. FIELD **VERIFY EXISTING CONDITIONS.**

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LIGHTING ANALYSIS NOTES:

- **AVERAGE FOOTCANDLES: 8.07** MAXIMUM FOOTCANDLES: 26.60
- MINIMUM FOOTCANDLES: 1.64
- MAXIMUM/MINIMUM RATIO: 16.2:1

AVERAGE/MINIMUM RATIO: 4.9:1




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No. Date Description 03/07/23 ISSUE FOR PERMIT & BID 1 05/24/23 | PERMIT REVIEW COMMENTS

ERIKSSON ENGINEERING ASSOCIATES, LTD., 2023 S.M.B. D.B.K.

ELECTRICAL SITE PLAN

262-784-3323 K&A #23025C 2845 S. Moorland Rd., New Berlin, WI 5315

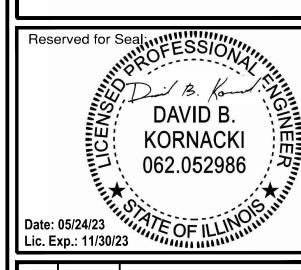Corporation Registration #184.005374
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KORNACKI & ASSOCIATES, INC.
Electrical Design Consultants
000 704 0000

Sheet No:

E101

FIXTURE SCHEDULE											23025C				
TYPE	INPUT WATTS	VOLTS	LUMENS	COLOF TEMP		_	0+ 90+	DESCRIPTION	MANUFACTURER	CATALOG NUMBER	SHIELDING	FINISH	MOUNTING	TROLS REMOTE	SEE NOTES
Е	(2) 368	VERIFY	52024	5000K		•		FLOODLIGHT	LITHONIA	(2) HLF1-LED-P5-50K-MFL-MVOLT-IS		MATCH EXISTING	POLE - SEE DETAIL		#1,2

NOTES:

- E.C. TO REUSE EXISTING LIGHTING CIRCUIT AND LIGHTING CONTROL CURRENTLY FEEDING EXISTING LIGHTING.
- E.C. TO PROVIDE NEW POLE AND LUMINAIRES. E.C. TO MATCH EXISTING POLE HEIGHT AND COLOR. PROVIDE NEW CONCRETE BASE IF REQUIRED. FIELD VERIFY EXISTING CONDITIONS.

SYMBOLS / ABBREVIATIONS

WALL BRACKET/WALL SCONCE FIXTURE - SEE FIXTURE SCHEDULE

SURFACE/PENDANT FIXTURE - SEE FIXTURE SCHEDULE RECESSED DOWNLIGHT FIXTURE - SEE FIXTURE SCHEDULE POLE & LUMINAIRE(S) FIXTURE - SEE FIXTURE SCHEDULE SWITCHED CIRCUIT BRANCH CIRCUIT ABOVE FINISHED FLOOR ABOVE FINISHED GRADE ARC FAULT INTERRUPTER AMPERES/AMPERAGE AUDIO VISUAL BATTERY BACKUP BELOW FINISHED CEILING **BUILT-IN OVERLOAD BREAKER** BAKED WHITE ENAMEL **COLOR BY ARCHITECT** CONTROL PANEL CRCT CIRCUIT CTL CONTROL DCP DOCK EQUIPMENT CONTROL PANEL DISCONNECT ELECTRICAL CONTRACTOR **EMERGENCY EXISTING RELOCATED** ELECTRONIC TIME CLOCK CONTROL EXISTING TO REMAIN EXISTING TO BE DEMO'D **EXISTING TO BE RELOCATED** ELECTRIC WATER COOLER FIRE ALARM ANNUNCIATOR PANEL FIRE ALARM CONTROL PANEL FULL LOAD AMPS FLOAT SWITCH FPC FIRE PROTECTION CONTRACTOR FURN FURNISHED **GENERAL CONTRACTOR GROUND FAULT CIRCUIT INTERRUPTER** GFCI GROUND HAND-OFF-AUTOMATIC SWITCH HOA HORSEPOWER HEATING AND VENTILATING CONTRACTOR ISOLATED GROUND INTEGRAL IN ROOM IN UNIT JUNCTION BOX KILOWATTS LIGHTING CONTROL PANEL LOCATION LOW TEMPERATURE LIGHT SWITCH LOW VOLTAGE THERMOSTAT MAGNETIC STARTER MAN MANUAL STARTER MINIMUM CIRCUIT AMPS MANUAL STARTER WITH PILOT LIGHT NIGHT LIGHT NU NEAR UNIT OVERHEAT PROTECTION OCCUPANCY SENSOR ON UNIT PUSH BUTTON PLUMBING CONTRACTOR PNEUMATIC ELECTRIC SWITCH PHOTO | PHOTOCELL PREWIRED REFRIGERATION CONTRACTOR REFRIGERATION CONTROL CONTRACTOR RECEPT RECEPTACLE SBA SELECTED BY ARCHITECT SEPARATE CIRCUIT SPSW SPEED SWITCH SS SOFT START SHUNT TRIP SWITCH LINE VOLTAGE THERMOSTAT

TO BE DETERMINED

UNIT MANUFACTURER UNLESS NOTED OTHERWISE

TRANSFORMER

VARIABLE FREQUENCY DRIVE


WEATHER PROOF ("WHILE-IN-USE")

TEMPERATURE CONTROL CONTRACTOR TEMPERATURE CONTROL PANEL

TIME CLOCK

VFD

XFMR

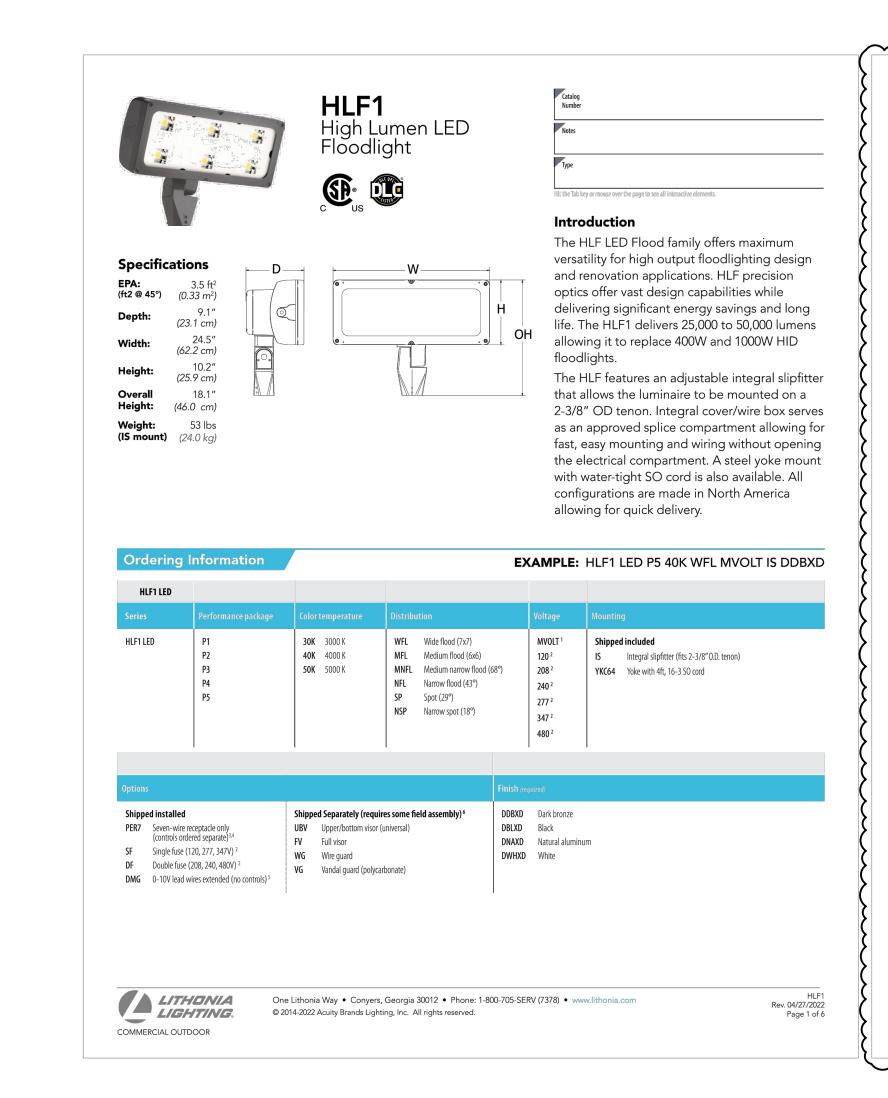

SSS Square Straight Steel Poles

for complete

For additional parts please order as replacements.

5. All RAD drilling's require a minimum top 0.D. of 4".

Accessories: Order as separate catalog number.

A LITHONIA LIGHTING

6. Insert "1" or "2" to designate fixture size; e.g. DM19AST2.

and orientation compatibility.

PL DT20 Plugs for ESX drillings

PL DT8 Plugs for DMxxAS drillings

4. Refer to the fixture spec sheet for the correct drilling template pattern

total height.

Example: Pole height is 25ft, A provision cannot be placed above 16ft.


ordering information.)


4C 4" 11g (0.120")

5C 5" 11g (0.120")

See technical

information table for complete ordering information.)

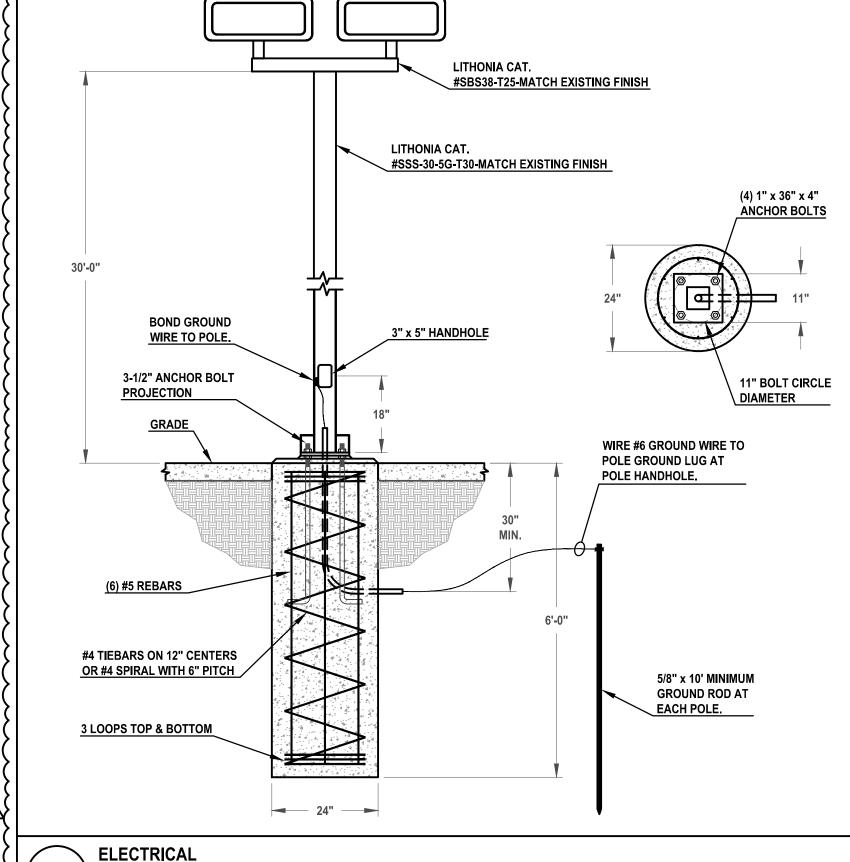

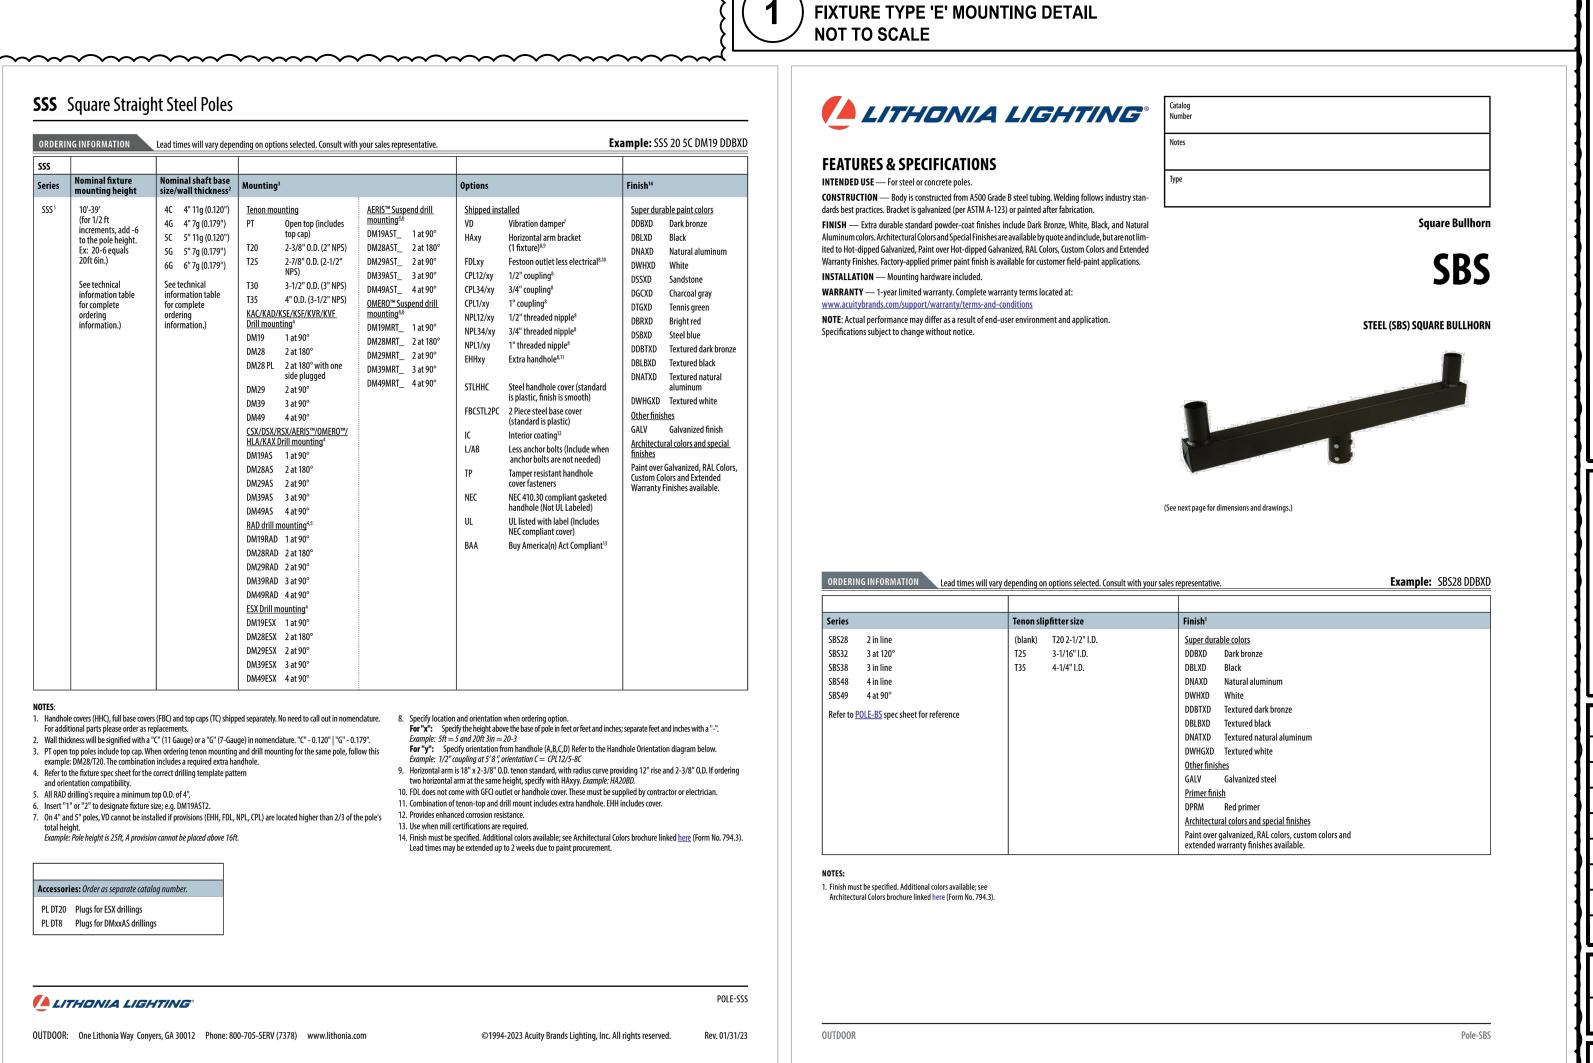



EMAIL INFO@EEA-LTD.COM

Professional Design Firm LICENSE No. 184-003220 Expires: 04/30/2023

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FESSION DAVID B. KORNACKI 062.052986 MIEOFILL Date: 05/24/23 Lic. Exp.: 11/30/23 No. Date Description

 \Box

03/07/23 ISSUE FOR PERMIT & BID 1 05/24/23 PERMIT REVIEW COMMENTS

ERIKSSON ENGINEERING ASSOCIATES, LTD., 2023 S.M.B. D.B.K.

SCHEDULES & DETAILS

Sheet Title:

Corporation Registration #184.005374

KORNACKI & ASSOCIATES, INC. Electrical Design Consultants 262-784-3323

K&A #23025C 2845 S. Moorland Rd., New Berlin, WI 531

E102

Project Type (From ab Project Category (From Above)	Media File #/Name	Project Category Cost	ADA Portion of Project Cate %	ADA Dollars Requested
Routes and Surfaces Elevators		1540	30800	20.00%
Routes and Surfaces Athletic Surfaces		1675	500 25125	15.00%
Routes and Surfaces Athletic Surfaces				#DIV/0!
				#DIV/0!
Total Project Cost	3215	00		
Total ADA Portion of Project Cost	5593	25		
Total % of ADA Dollars Requested	17.40	9%		