12/12/2024

### Meadowlark Park by Jim Holder in Member District ADA Project id. 49066911 Request 250 E Wood Street Palatine, Illinois 60067 United States 847-705-5131

ADAProjects@palatineparks.org

### **Original Submission**

Title

Score Jim Holder Name Job Title **Director of Parks & Planning F-mail Address** adaprojects@palatineparks.org Phone Number 847-705-5131 Park District Palatine Meadowlark Park **Project Location Project Status** New **Recreation Facilities and Amenities** Project Type Routes and Surfaces Recreation Facilities Benches- Picnic Tables and Amenities- select Playgrounds- Play Components a Project Category below: Routes and Accessible Routes- Means of Egress Surfaces-select a Curb Ramps **Project Category Parking Spots** below: **Play Surfaces** Ramps Walking Surfaces Benefits of the The new development will allow individuals with mobility issues to access Project the park, playground, adventure play area, the shelter, Bago boards (4), and drinking fountain from the parking lot and the neighborhood. The project includes an accessible swing seat, transfer stations, three concrete sloped entries into play areas, and pathways around the the park to allow disabled individuals to use the playgrounds, Bago boards, and shelter.

12/12/2024

Items that will become ADA Compliant	Swing, both playgrounds, ground play features, shelter, drinking fountain, pathways within the park, parking lot, and two sets of Bagos.

The project is	The 2010 Standards for Accessible Design
designed or	The Illinois Accessibility Code
constructed, or	ASTM F 1951 Standard for Accessible Playground Surfaces
applies human	
resources, to comply	
with:	

Upload Project Related Files, Photos, Videos or Audio

01\_Meadowlark\_Park\_ADA\_Calculations.pdf

02\_Revised\_plan\_set\_meadowlark.pdf

03\_Agreement\_Hacienda\_Landscaping\_SIGNED.pdf

04\_Hacienda\_Bid.pdf

05\_PO\_Play\_Design\_Scapes\_Dk\_Fountain.pdf

06\_PO\_Play\_Illinois\_Adventure\_Eq.pdf

07\_PO\_Play\_Illinois\_Playground\_Eq.pdf

Budget Table for ADA Related Expenses

### Budget Table.xlsx

ADA Dollars Requested

235371.48

Notes related to requested amount

TREE PROTECTION ( FENCE \L5.0  $\sim\sim\sim\sim$ /2 Properly cap and reseal ightarrow existing well and file with Cook County Remove and dispose of asphalt paving Remove and dispose of stump


TEMPORARY / 2 CONSTRUCTION FENCE \L5.0 Remove and dispose of concrete curb and gutter Remove and dispose of existing light pole Remove and dispose of existing light pole Remove and dispose of asphalt paving Remove and dispose of existing light pole Remove and dispose of sign Remove and dispose of asphalt paving

RIM: 846.84 INV: 839.44(SE,NW)POURED BENCH-INV: 840.84(SSE)

RIM: 845.15 INV: 841.05(SE) INV: 841.25(NW) DIRECTIONS IN FIELD NOTES ARE CONFLICTING, VERIFY.

RIM: 851.00 INV: 845.60(S) --INV: 845.70(N)

C.S.

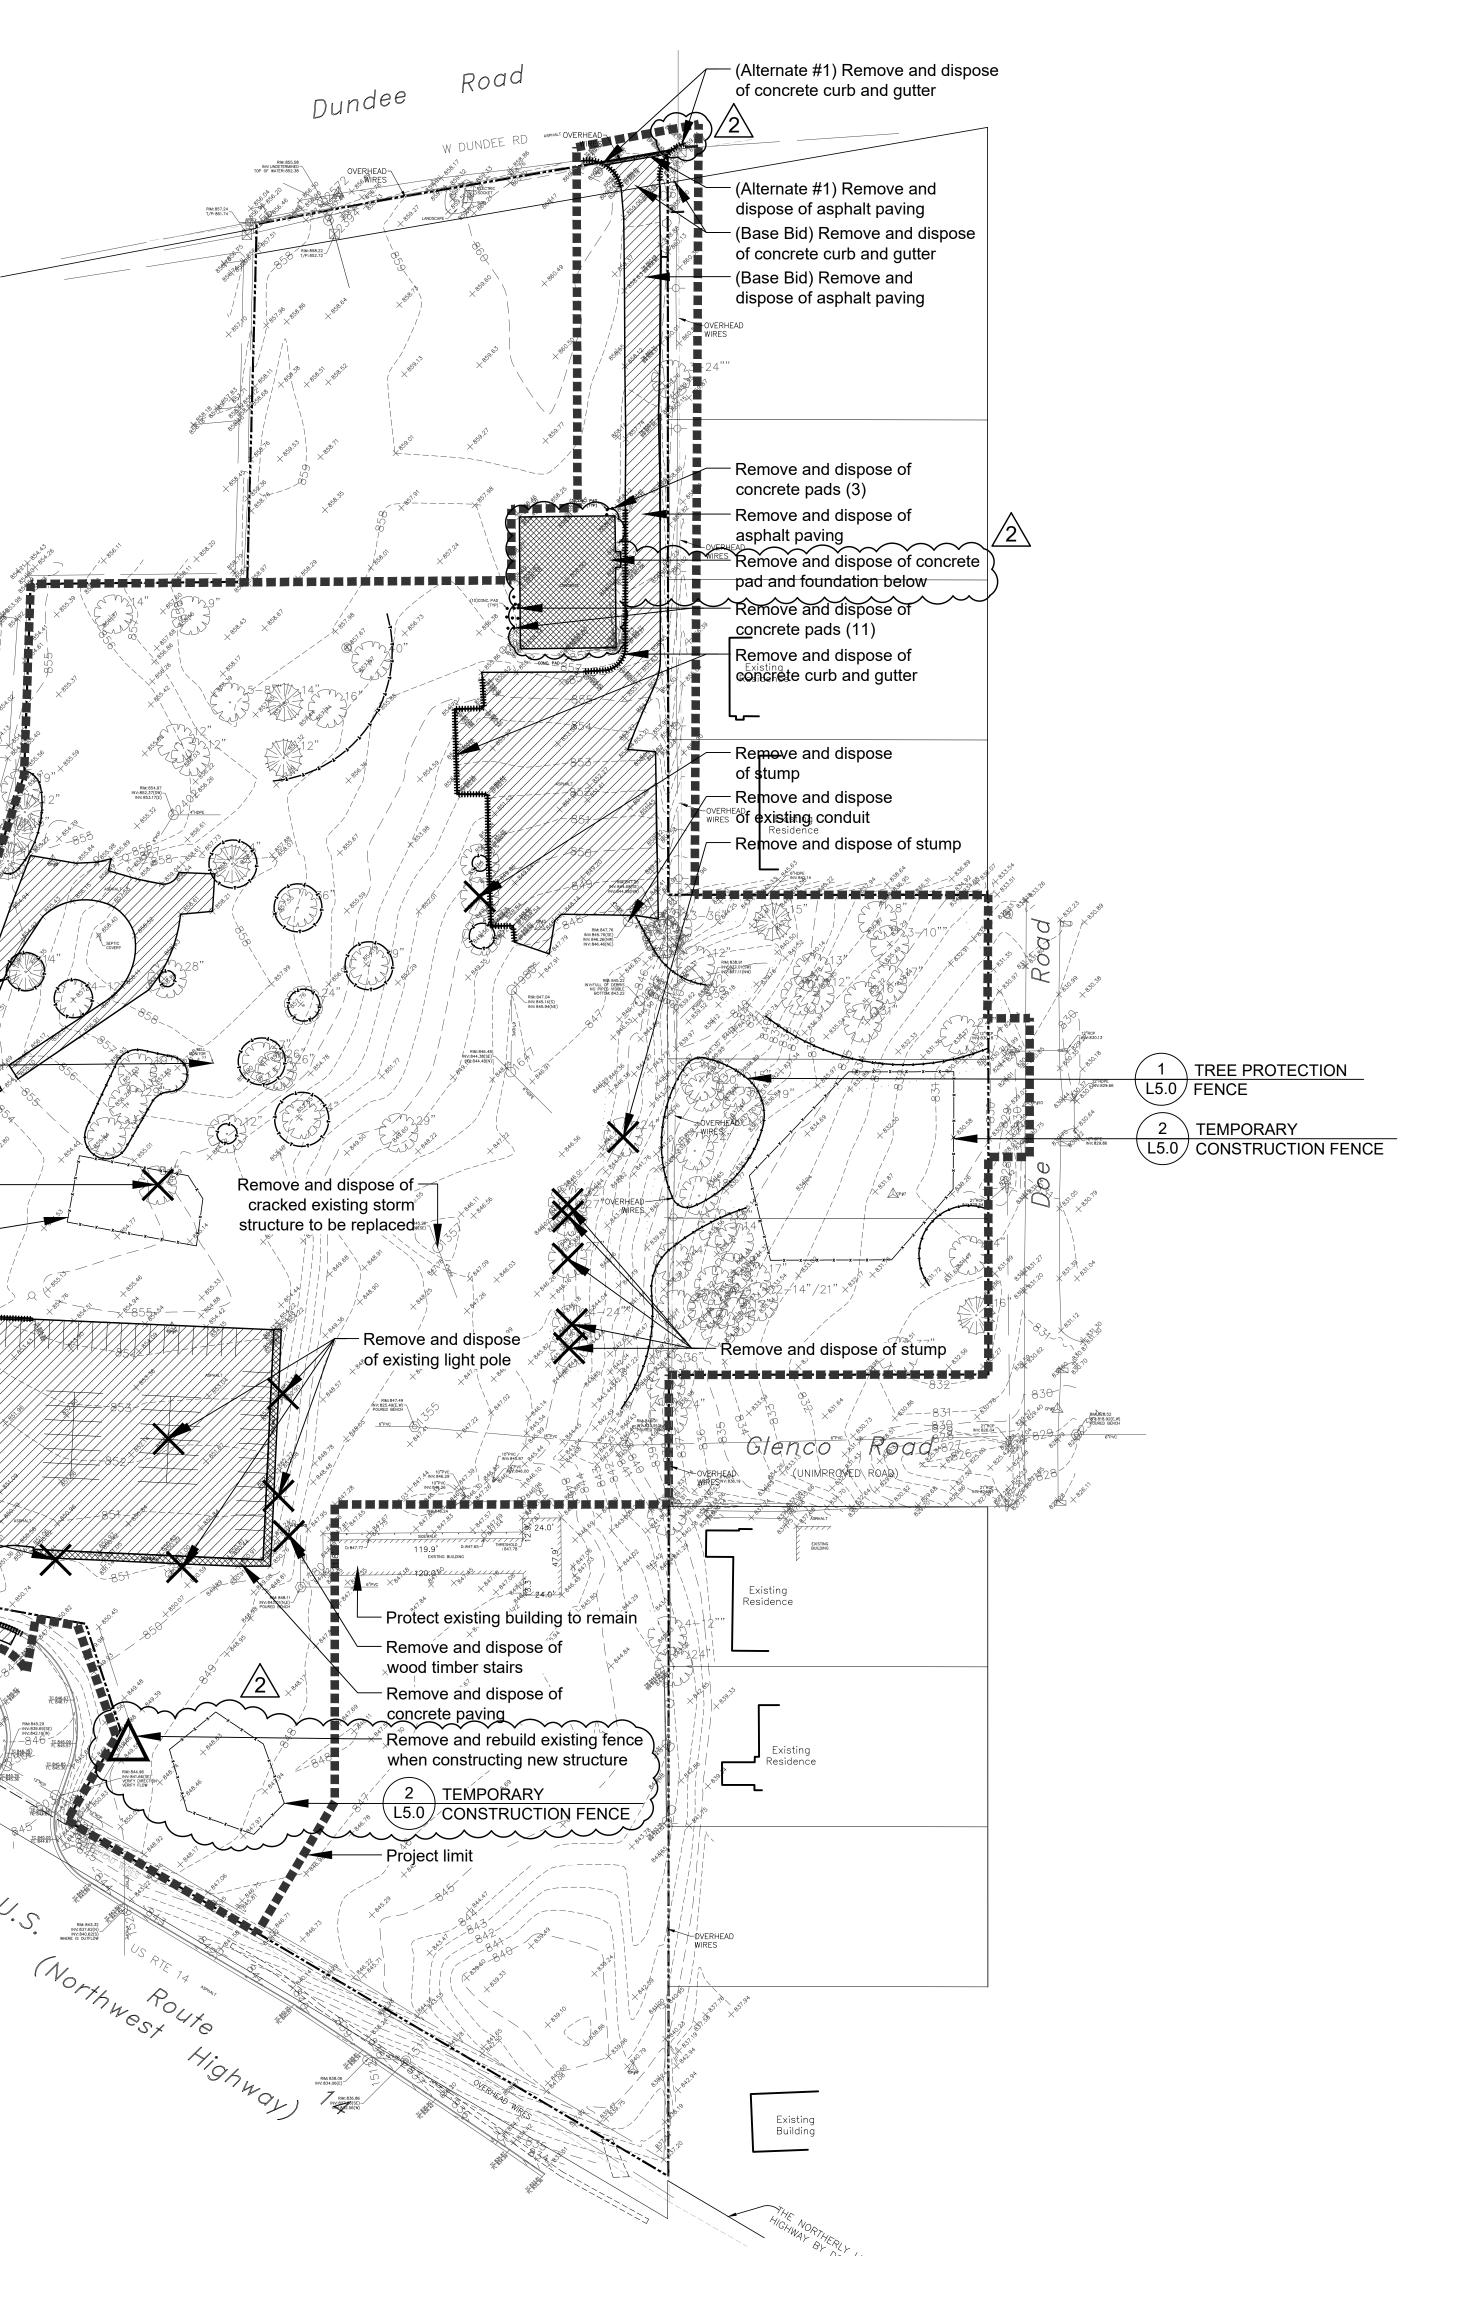

### SITE PREPARATION AND REMOVALS NOTES

- 1. Contractor shall install construction fence as indicated construction prior to beginning work. Maintain and adjust construction fencing as needed during progress of construction. Staging and construction access shall be approved by Owner.
- 2. Contractor shall install tree protection fencing as shown on the plans prior to beginning work. Maintain and adjust tree protection fencing as needed during progress of construction. Storage of materials, vehicular access, and all other construction activities are strictly prohibited within the limits of the tree protection fencing.
- 3. Plans indicate general location and limits of removals. Contractor shall perform removals only as necessary for construction of proposed improvements. No additional payments will be made for removals or restoration not required to construct the improvements as drawn and specified. Refer to Layout Plan for more specific information regarding proposed improvements and verify conditions in the field prior to performing removals.
- 4. Sawcut and remove concrete paving to nearest joint where indicated. All saw cuts required for removal items to be included in the unit cost of that particular pay item.
- 5. Tree stumps shall be ground to a minimum depth of 18" below existing grade or as required to properly perform the work.
- 6. Remove and dispose of turf where planting beds are designated. Refer to Planting Plan for limits of proposed landscape improvements.
- 7. Where turf or plantings are proposed in existing paved areas, remove all base material.
- 8. Remove all utilities designated for removal to extent required for improvements, unless otherwise noted. Cap ends of any remaining underground conduit and piping, and pull all electrical wire out at source.
- 9. Items indicated for Removal shall include complete removal of above grade item and below grade appurtances (foundations, urban fill, wiring, piping, etc.) including disposal off-site following applicable codes and ordinances, unless otherwise shown on the plans.
- 10. Contractor to protect all existing utilities and all other site features not designated for removal. Contractor is responsible for replacing/repairing any existing utilities or other site features damaged during construction to the original condition at no cost to the Owner.
- 11. Contractor responsible for maintaining existing utility services (electrical, sanitary, storm) during construction unless otherwise indicated in the Contract Documents.
- 12. Contractor shall coordinate all work so public sidewalk remains open throughout construction.
- 13. Refer to civil and electrical plans for additional utility adjustments and removals.
- 14. Refer to specifications for additional conditions, standards and notes.

### SITE PREPARATION AND REMOVALS LEGEND

Remove and dispose concrete paving and gravel base. Remove subgrade material as needed. Remove and dispose asphalt paving and

gravel base. Remove subgrade material as needed. (Alternate #1) Remove and dispose asphalt

paving and gravel base. Remove subgrade material as needed.

Tree Protection Fence

Item to be removed



 $\sim\sim\sim\sim\sim$ 

Item to be salvaged/repaired

Concrete curb and gutter to be removed -x-x-x-x---x---- Construction Fence

Project Limit Line



February 15, 2024 REVISIONS

Issue for Bid

Issue 2 02/27/24 Addendum #2

CHECKED BY

DNF

DRAWN BY CAS

SHEET TITLE Site Preparation and **Removals Plan** 

> SCALE IN FEET 1" = 60'

0' 30' 60' 180' SHEET NUMBER NORTH

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# PREPARED FOR Palatine Park District

250 East Wood Street, Palatine, Illinois, 60067

### PROJECT


## Meadowlark Park **Final Design** Phase One


1502 W Northwest Highway, Palatine, Illinois, 60067

> CONSULTANTS Civil Engineer Eriksson Engineering Associates Grayslake, Illinois 60030 T 847.223.4804

> > Electrical Engineer Nova Engineering PC Schererville, Indiana 46375 T 219.865.3352



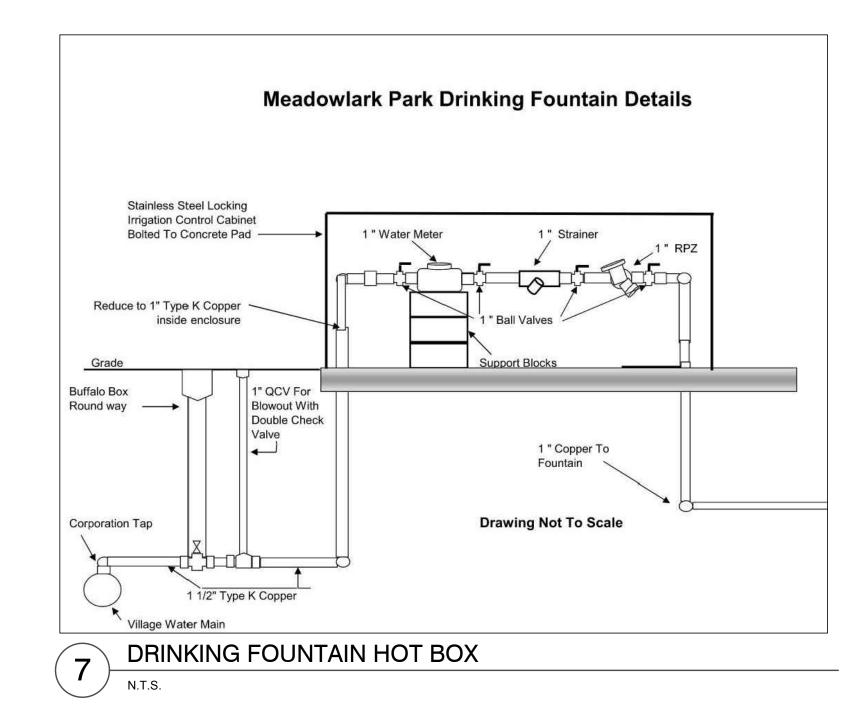

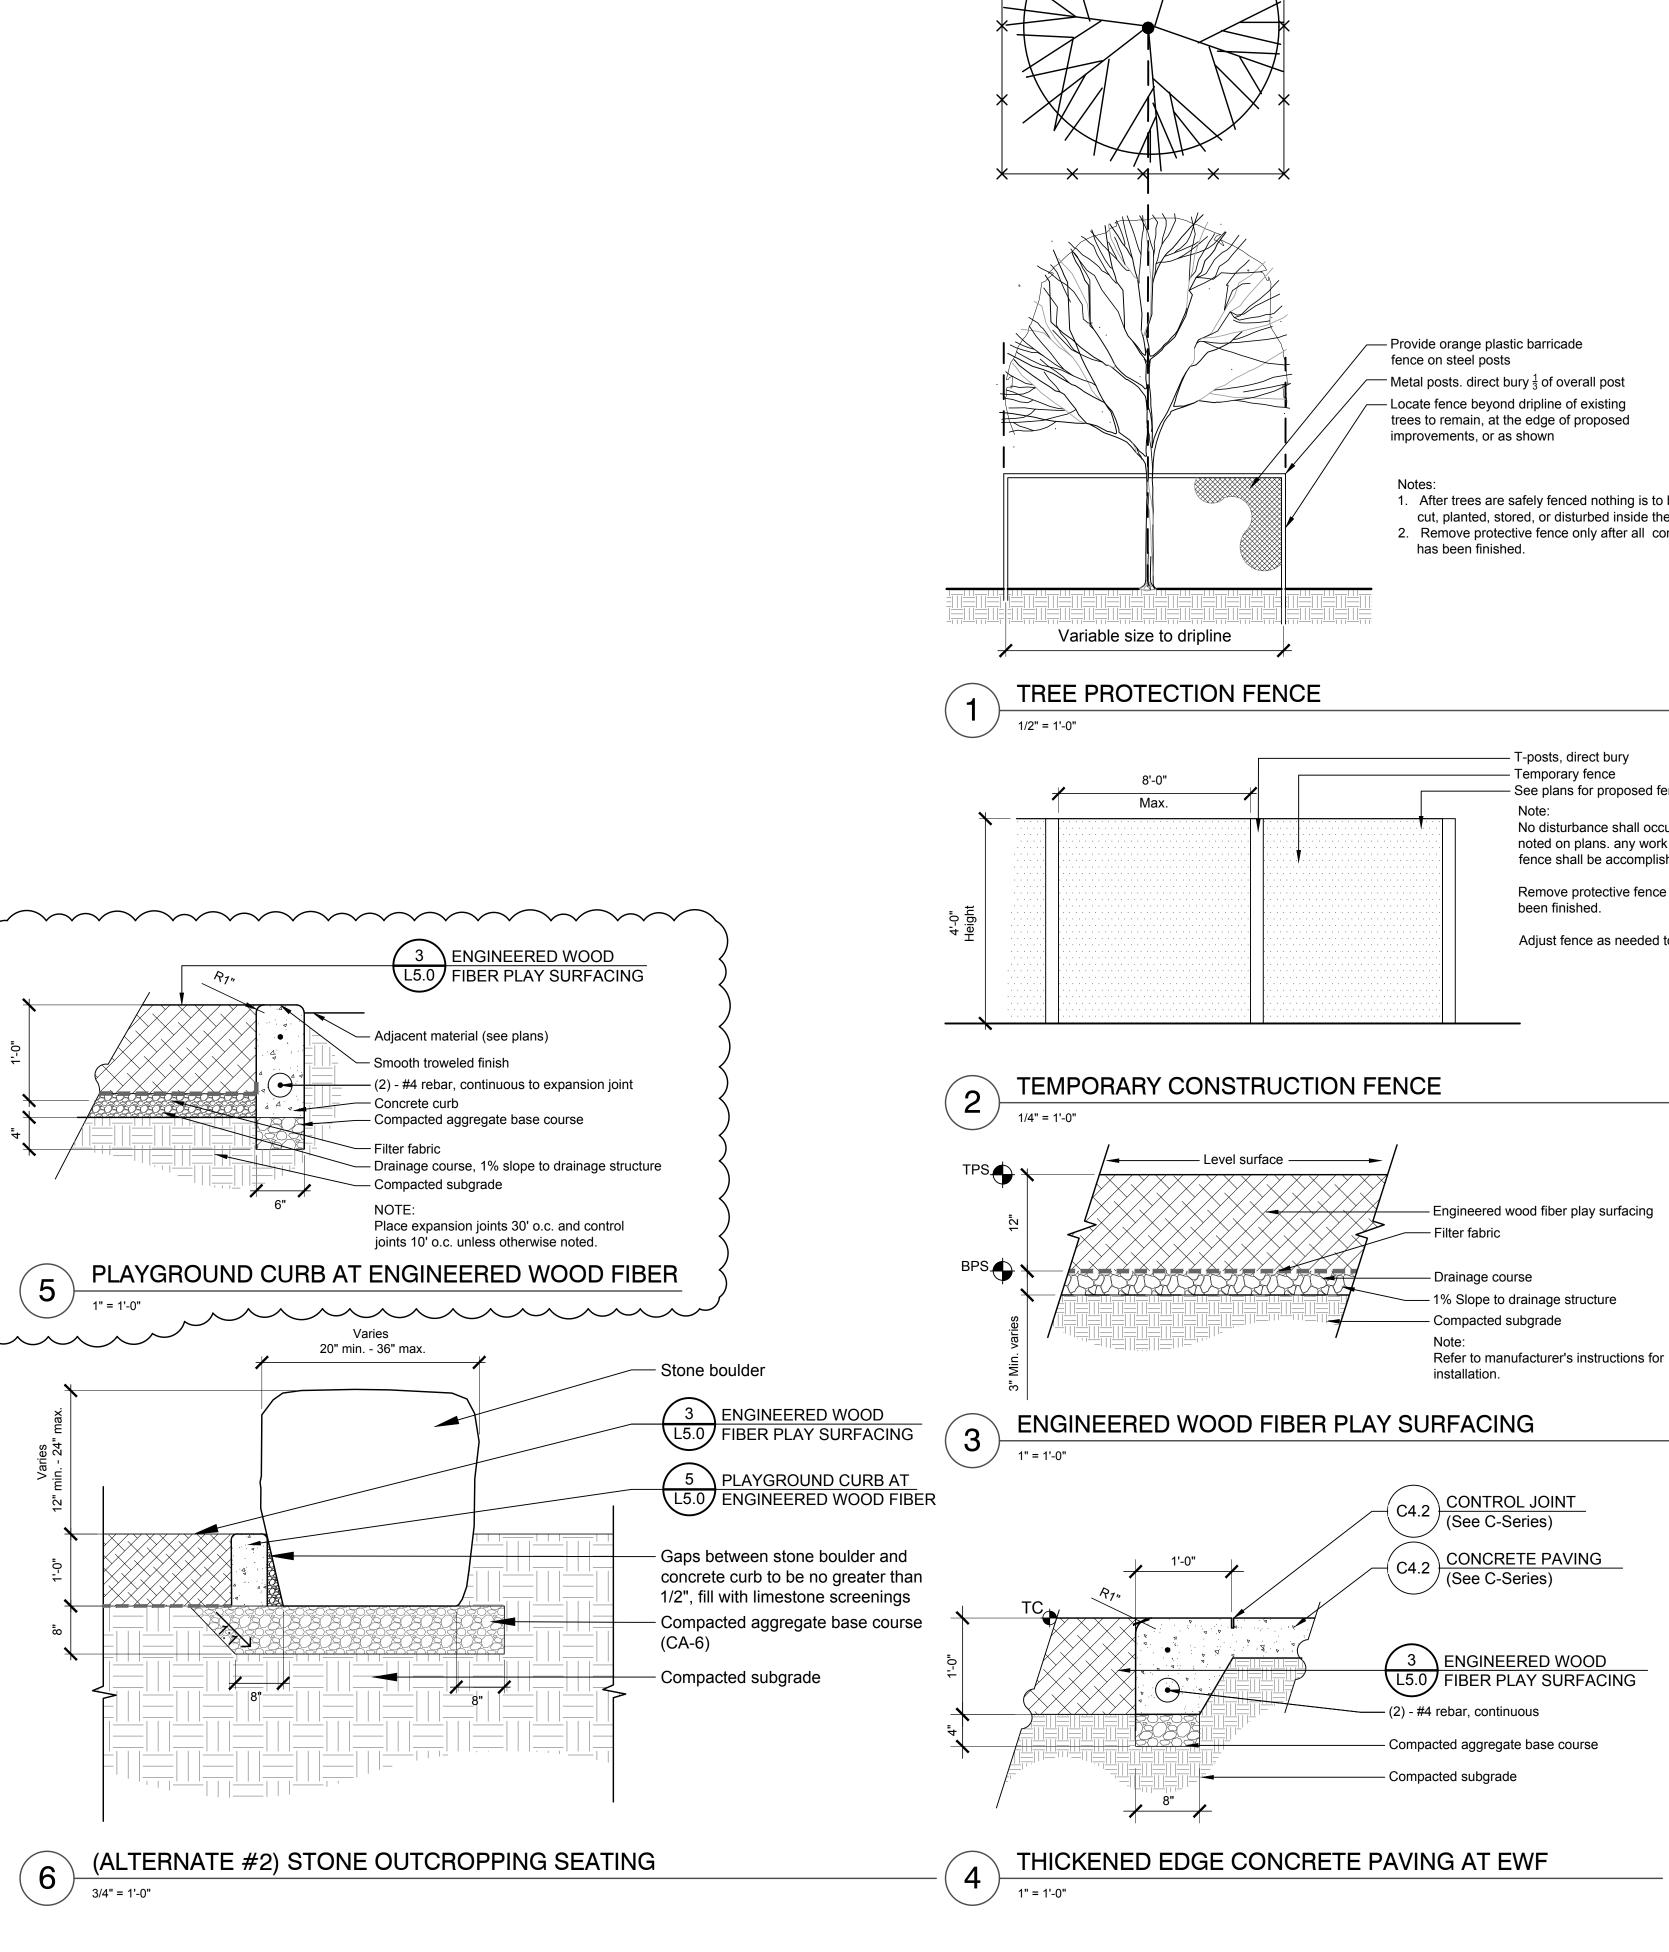



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1. After trees are safely fenced nothing is to be raked out, cut, planted, stored, or disturbed inside the fence. 2. Remove protective fence only after all construction work

See plans for proposed fence location

No disturbance shall occur within the protective fence unless noted on plans. any work to be done within the protective fence shall be accomplished without mechanized equipment.

Remove protective fence only after all construction work has


Adjust fence as needed to facilitate construction.

Issue for Bid February 15, 2024 REVISIONS Issue No Date 2 02/27/24 Addendum #2 CHECKED BY DRAWN BY DNF CAS SHEET TITLE Details

> SCALE IN FEET as noted

SHEET NUMBER

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. NUTES
Shall Match Village of
ng the Curbline, Unless Is Intended That the Frame n the Flowline Of The Where No Gutter Exists.
R1713—B Frame & Closed rm" or "Sanitary"

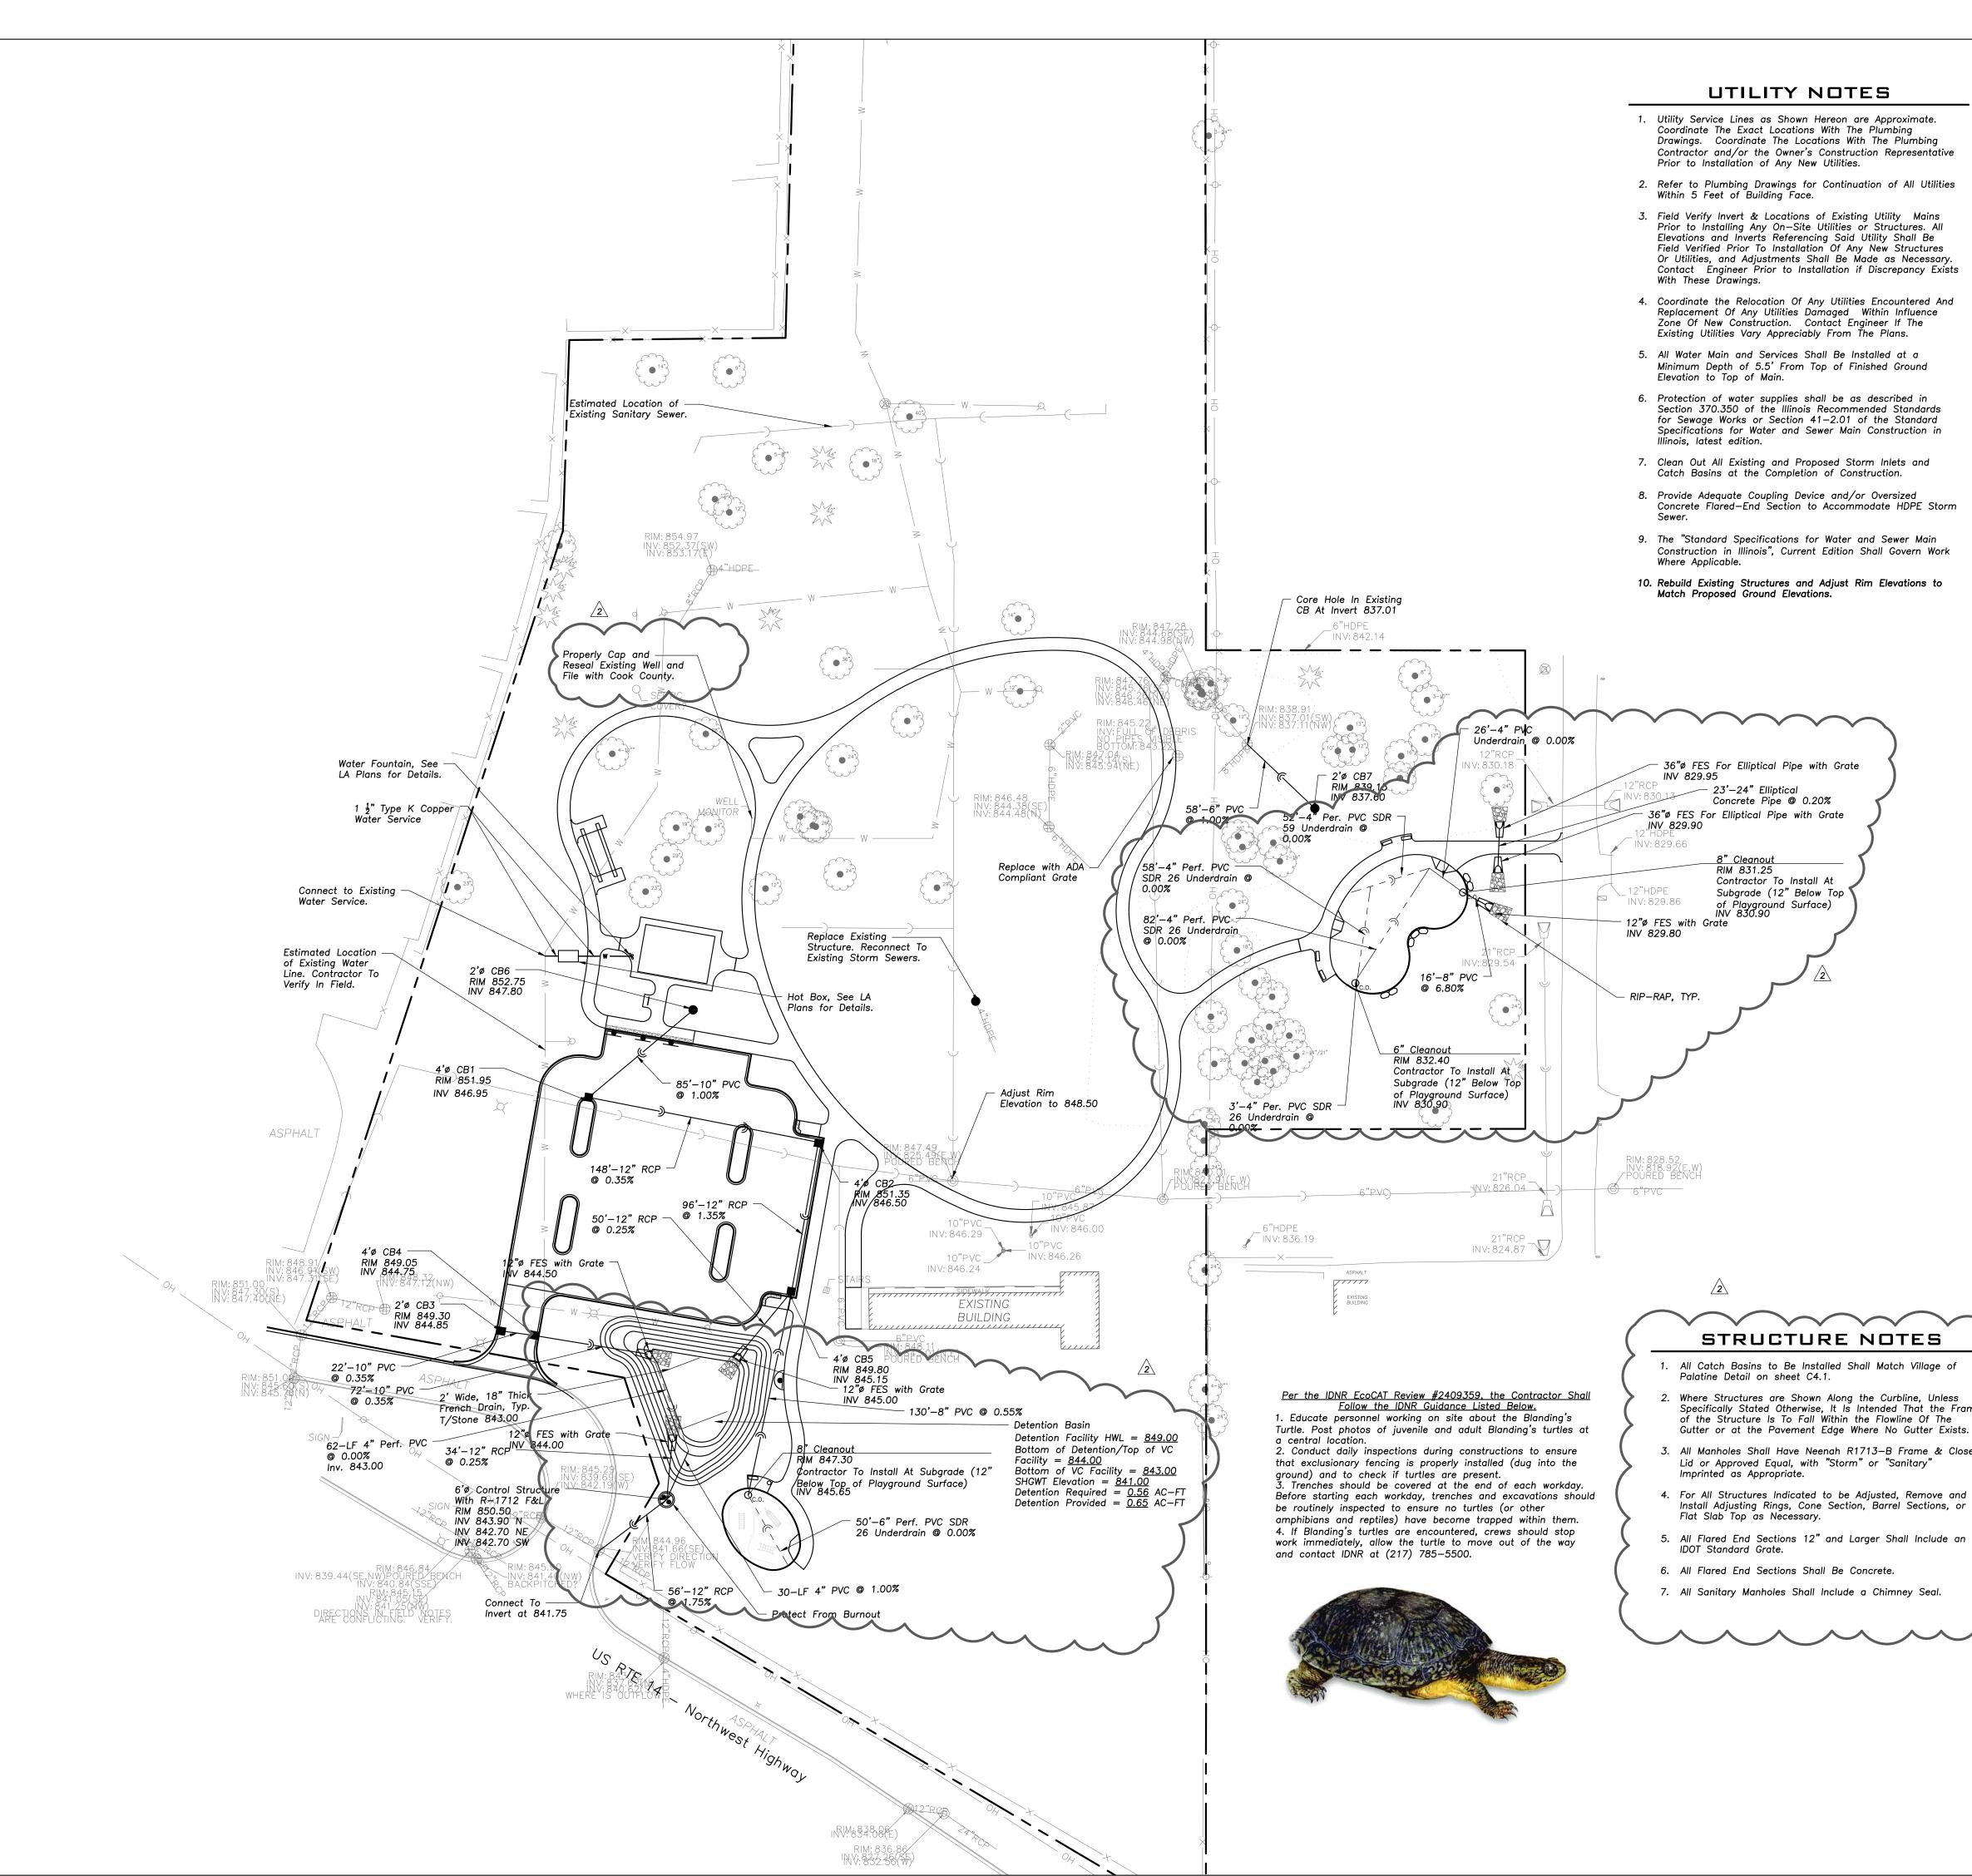	N	
0	50	100 1
	Scale: 1"=50 LEGEND	,
EXISTING		PROPOSED
$\bigcirc$	Manhole	۲
$\bigoplus$	Catch Basin	•
	Inlet Area Drain	
	Area Drain Clean Out	
0 <sub>c.o.</sub>	Flared End Section	
 )	Storm Sewer	 
	Sanitary Sewer	
_>	Combined Sewer	<b>—</b>
W	Water Main	——w—
— G ———	Gas Line	G
-OH	Overhead Wires	——он——
- E	Electrical Cable (Buried)	——E——
- T	Telephone Line	T
Q Q	Fire Hydrant	<b>A</b>
$\otimes$	Valve Vault	$\mathbf{\Theta}$
≥ <sub>B</sub>	Buffalo Box	€ <sub>B</sub>
D <sub>DS</sub>	Downspout	O <sub>DS</sub>
) <sub>BOL</sub>	Bollard	O <sub>BOL</sub>
⊗ <sub>c</sub> ™c	Gas Valve	
Ø <sub>g</sub> D <sub>e</sub>	Gas Meter Electric Meter	
_		
© <sub>e</sub>	Electric Manhole	
H	Hand Hole	¥
~	Light Pole	<b>A</b>
—X	Light Pole w/ Mast Arm	
)-	Utility Pole	-0-
] <sub>T</sub>	Telephone Pedestal	
D <sub>T</sub>	Telephone Manhole	
	Sign	•
×	Fence	xx
2	Accessible	<u>L</u>
Alb.	Parking Stall	
	Curb & Gutter	
20.50	Depressed Curb Curb Elevation	
82.50 82.00	Curb Elevation Gutter Elevation	<u>C 782.50</u> G 782.00
83.25	Pavement Elevation	P 783.25
32.10	Sidewalk Elevation	W 782.10
.0	Ground Elevation	
785.20	Top of Retaining Wall Elevation	
	Swale	•••
31	Contour Line	
Ê	Deciduous Tree	
tit	Coniferous Tree	
$\searrow$	Brushline	
	Tree Protection	x
	Fencing at Drip Line	

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The Drawings.

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- 9. Provide An As-built Survey Prepared By A Licensed Professional Land Surveyor In Accordance With The Authorities Having Jurisdiction Which Shall Include As a Minimum All Detention Basins and Best Management Practices, Include All Storm and Sanitary Sewers, Structure Locations, Sizes, Rim and Invert Elevations, Final Detention Volume Calculations For The Basin(s), Watermain and Valve and Appurtenance Locations.
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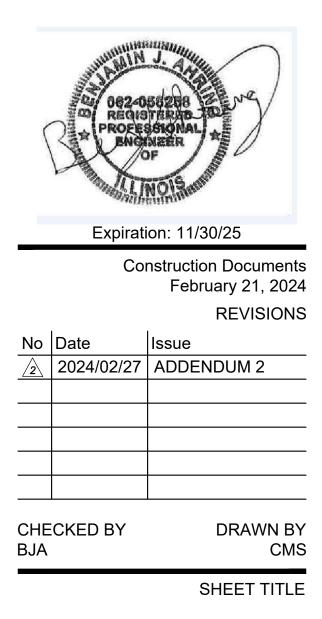
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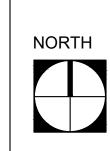
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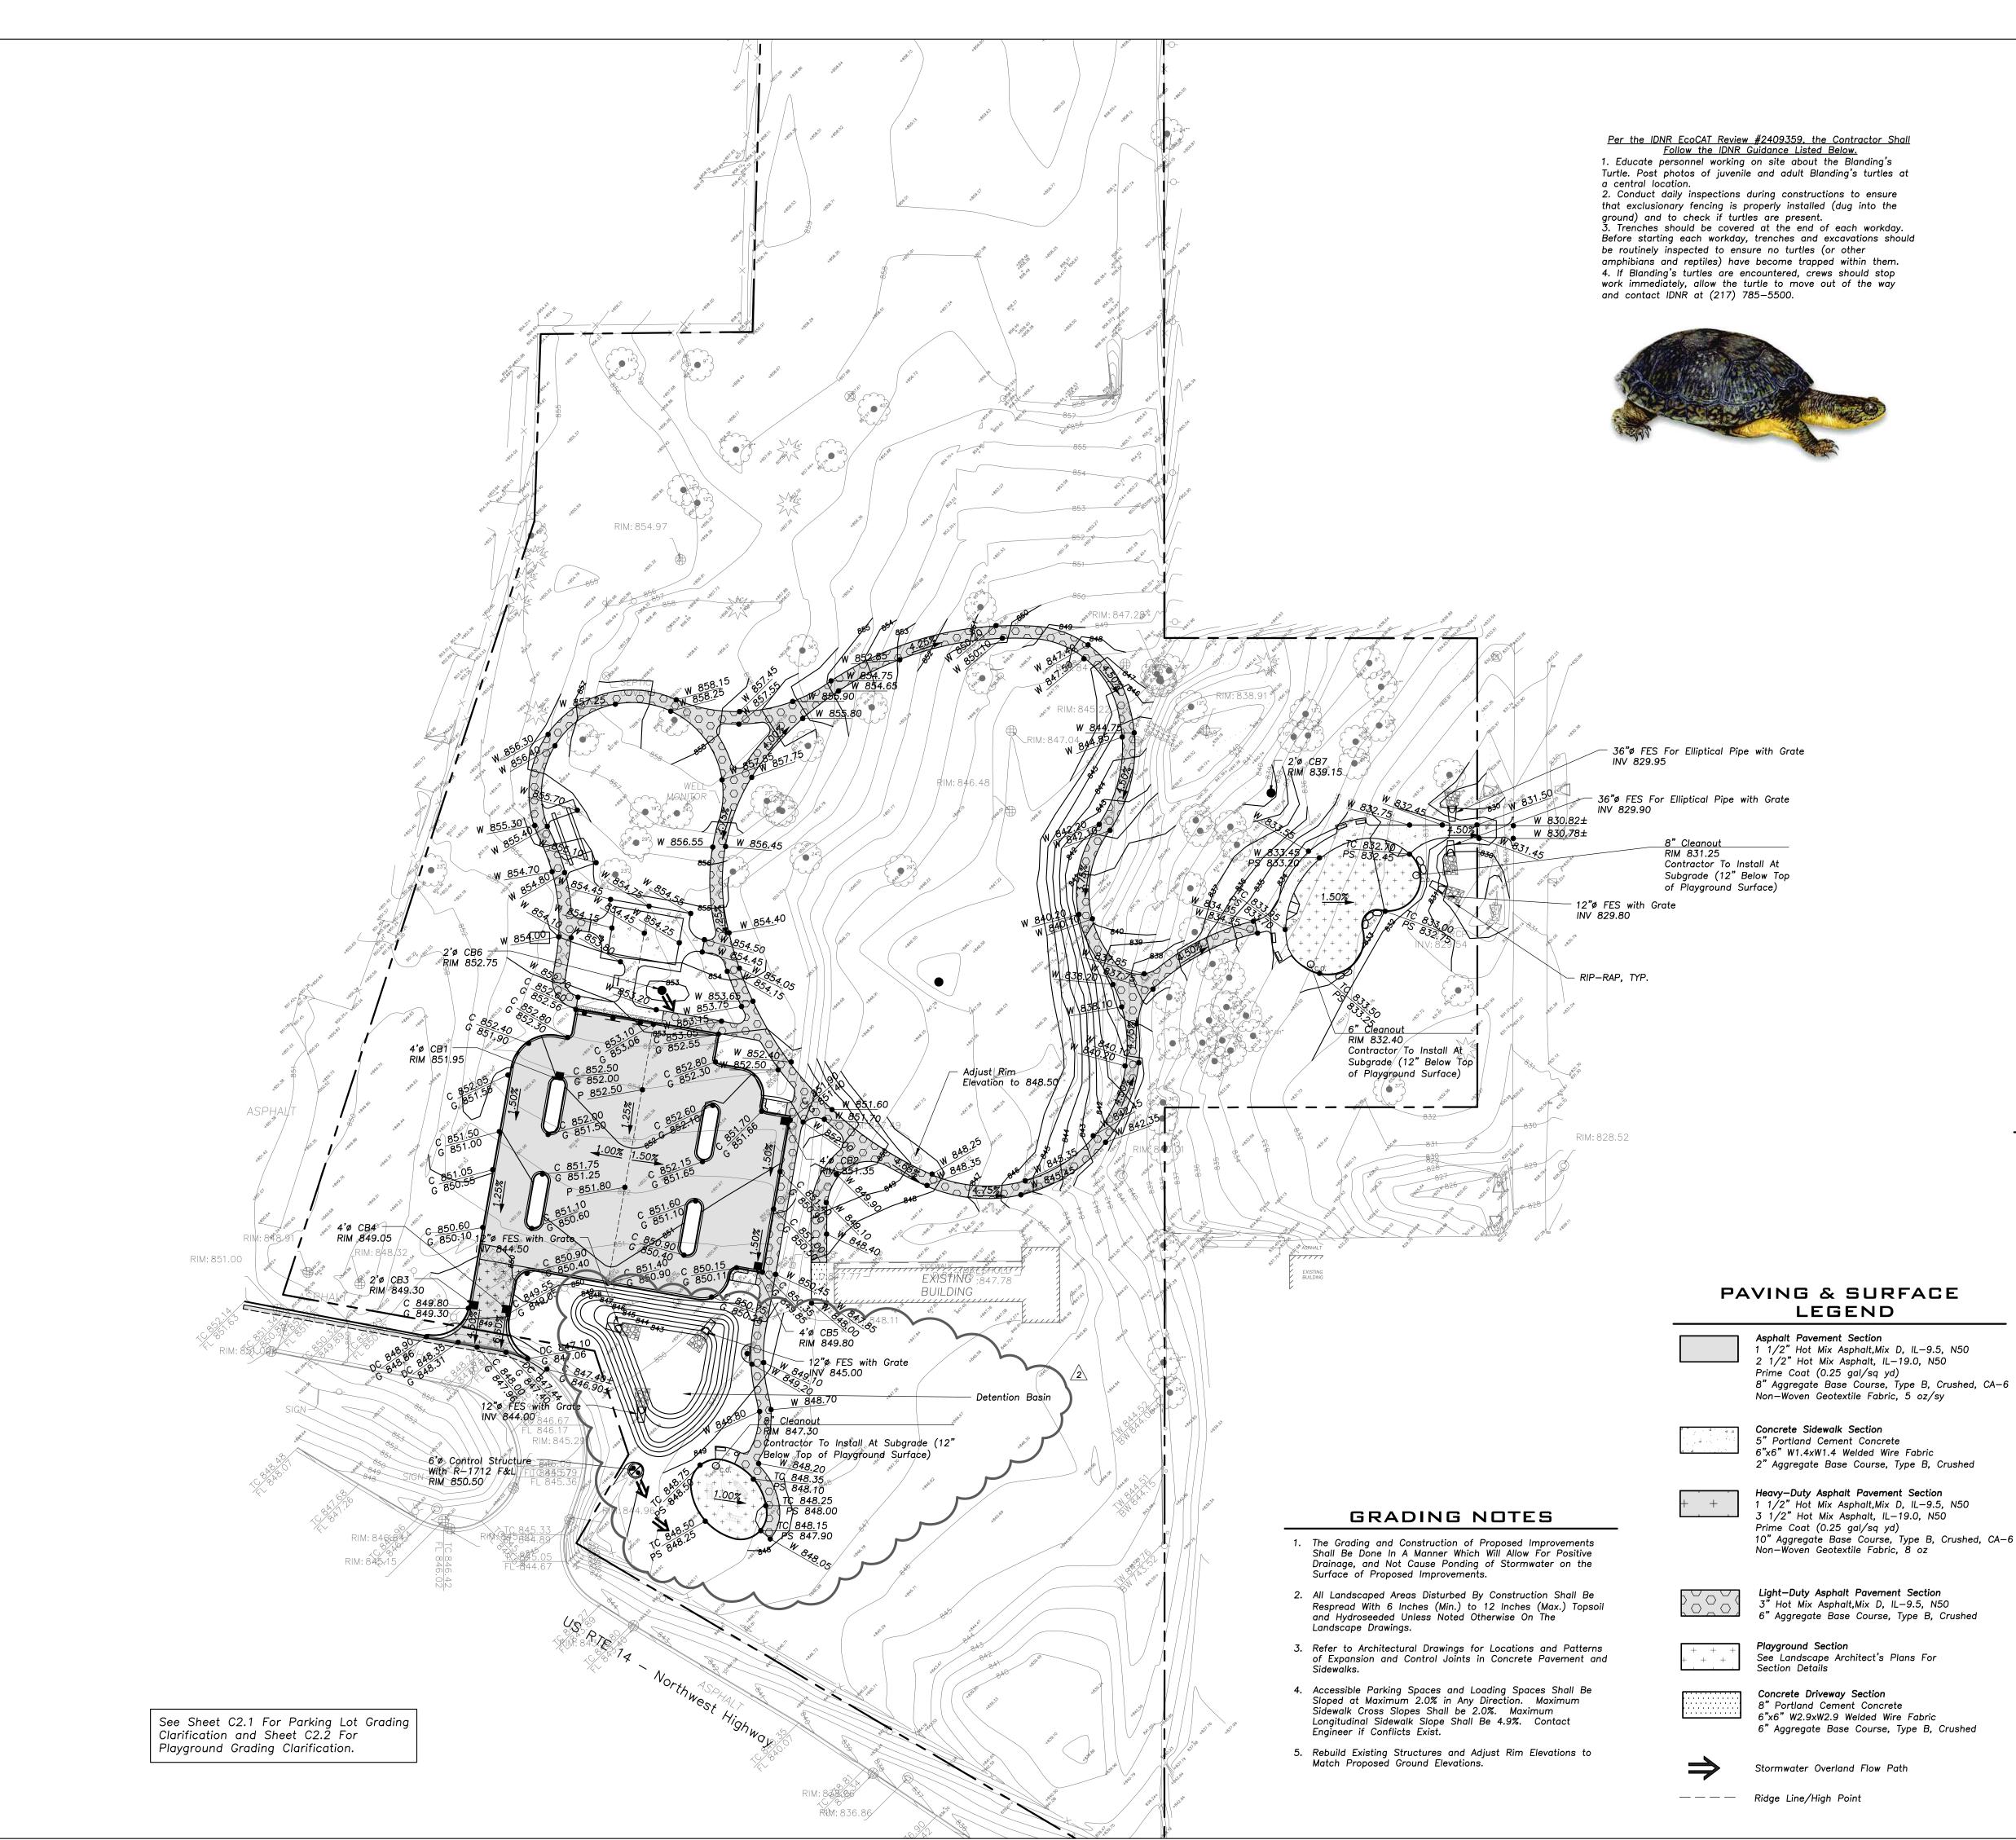
> Electrical Engineer Nova Engineering PC Schererville, Indiana 46375 T 219.865.3352



# SITE UTILITY PLAN







Scale: 1"=50' LEGEND EXISTING PROPOSED Manhole Catch Basin Inlet Area Drain Clean Out  $\Box$ Flared End Section Storm Sewe \_\_\_\_)\_\_\_\_ Combined Sev \_\_\_\_\_w \_\_\_\_\_ \_\_\_\_\_G\_\_\_\_\_ Gas Line \_\_\_\_\_OH\_\_\_\_\_ **Overhead Wire** Electrical Cable ——E—— \_\_\_\_\_T \_\_\_\_ Telephone Line Fire Hydrant . Valve Vault Buffalo Box Downspout ODS Bollard OBOL Gas Valve Gas Meter Electric Meter Electric Manhole Hand Hole X Light Pole Light Pole w/ Mast Arm Θ----Utility Pole -0-Telephone Pedestal Telephone Manhole Fence (Sr Parking Stal Curb & Gutter \_\_\_\_\_ epressed Curt Curb Elevation C 782.50 G 782.00 × C 782.50 x G 782.00 Gutter Elevation <u>P 783.25</u> x P 783.25 Pavement Elevatior <u>W 782.10</u> × W 782.10 Sidewalk Elevation x 784.0 <sub>x</sub> 784.0 Ground Elevation T/W 785.20 ор of Retaining Wall  $\cdots$ •• ------Swale \_\_\_\_\_781\_\_\_\_\_ Contour Line Deciduous Tree Coniferous Tree  $\frown \frown \frown \frown \frown$ Brushline

## **GENERAL NOTES**

Tree Protection Fencing at Drip Line

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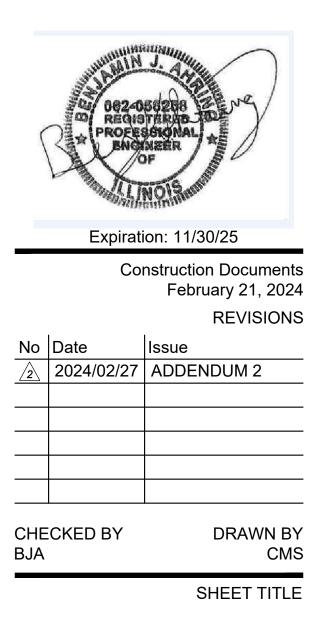
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## SITE GRADING AND PAVING PLAN

NORTH





1/2" Hot Mix Asphalt,Mix D, IL-9.5, N50

Prime Coat (0.25 gal/sq yd) 8" Aggregate Base Course, Type B, Crushed, CA—6


2" Aggregate Base Course, Type B, Crushed

1/2" Hot Mix Asphalt,Mix D, IL-9.5, N50 5 1/2" Hot Mix Asphalt, IL—19.0, N50

Light-Duty Asphalt Pavement Section Hot Mix Asphalt, Mix D, IL-9.5, N50

See Landscape Architect's Plans For

6"x6" W2.9xW2.9 Welded Wire Fabric

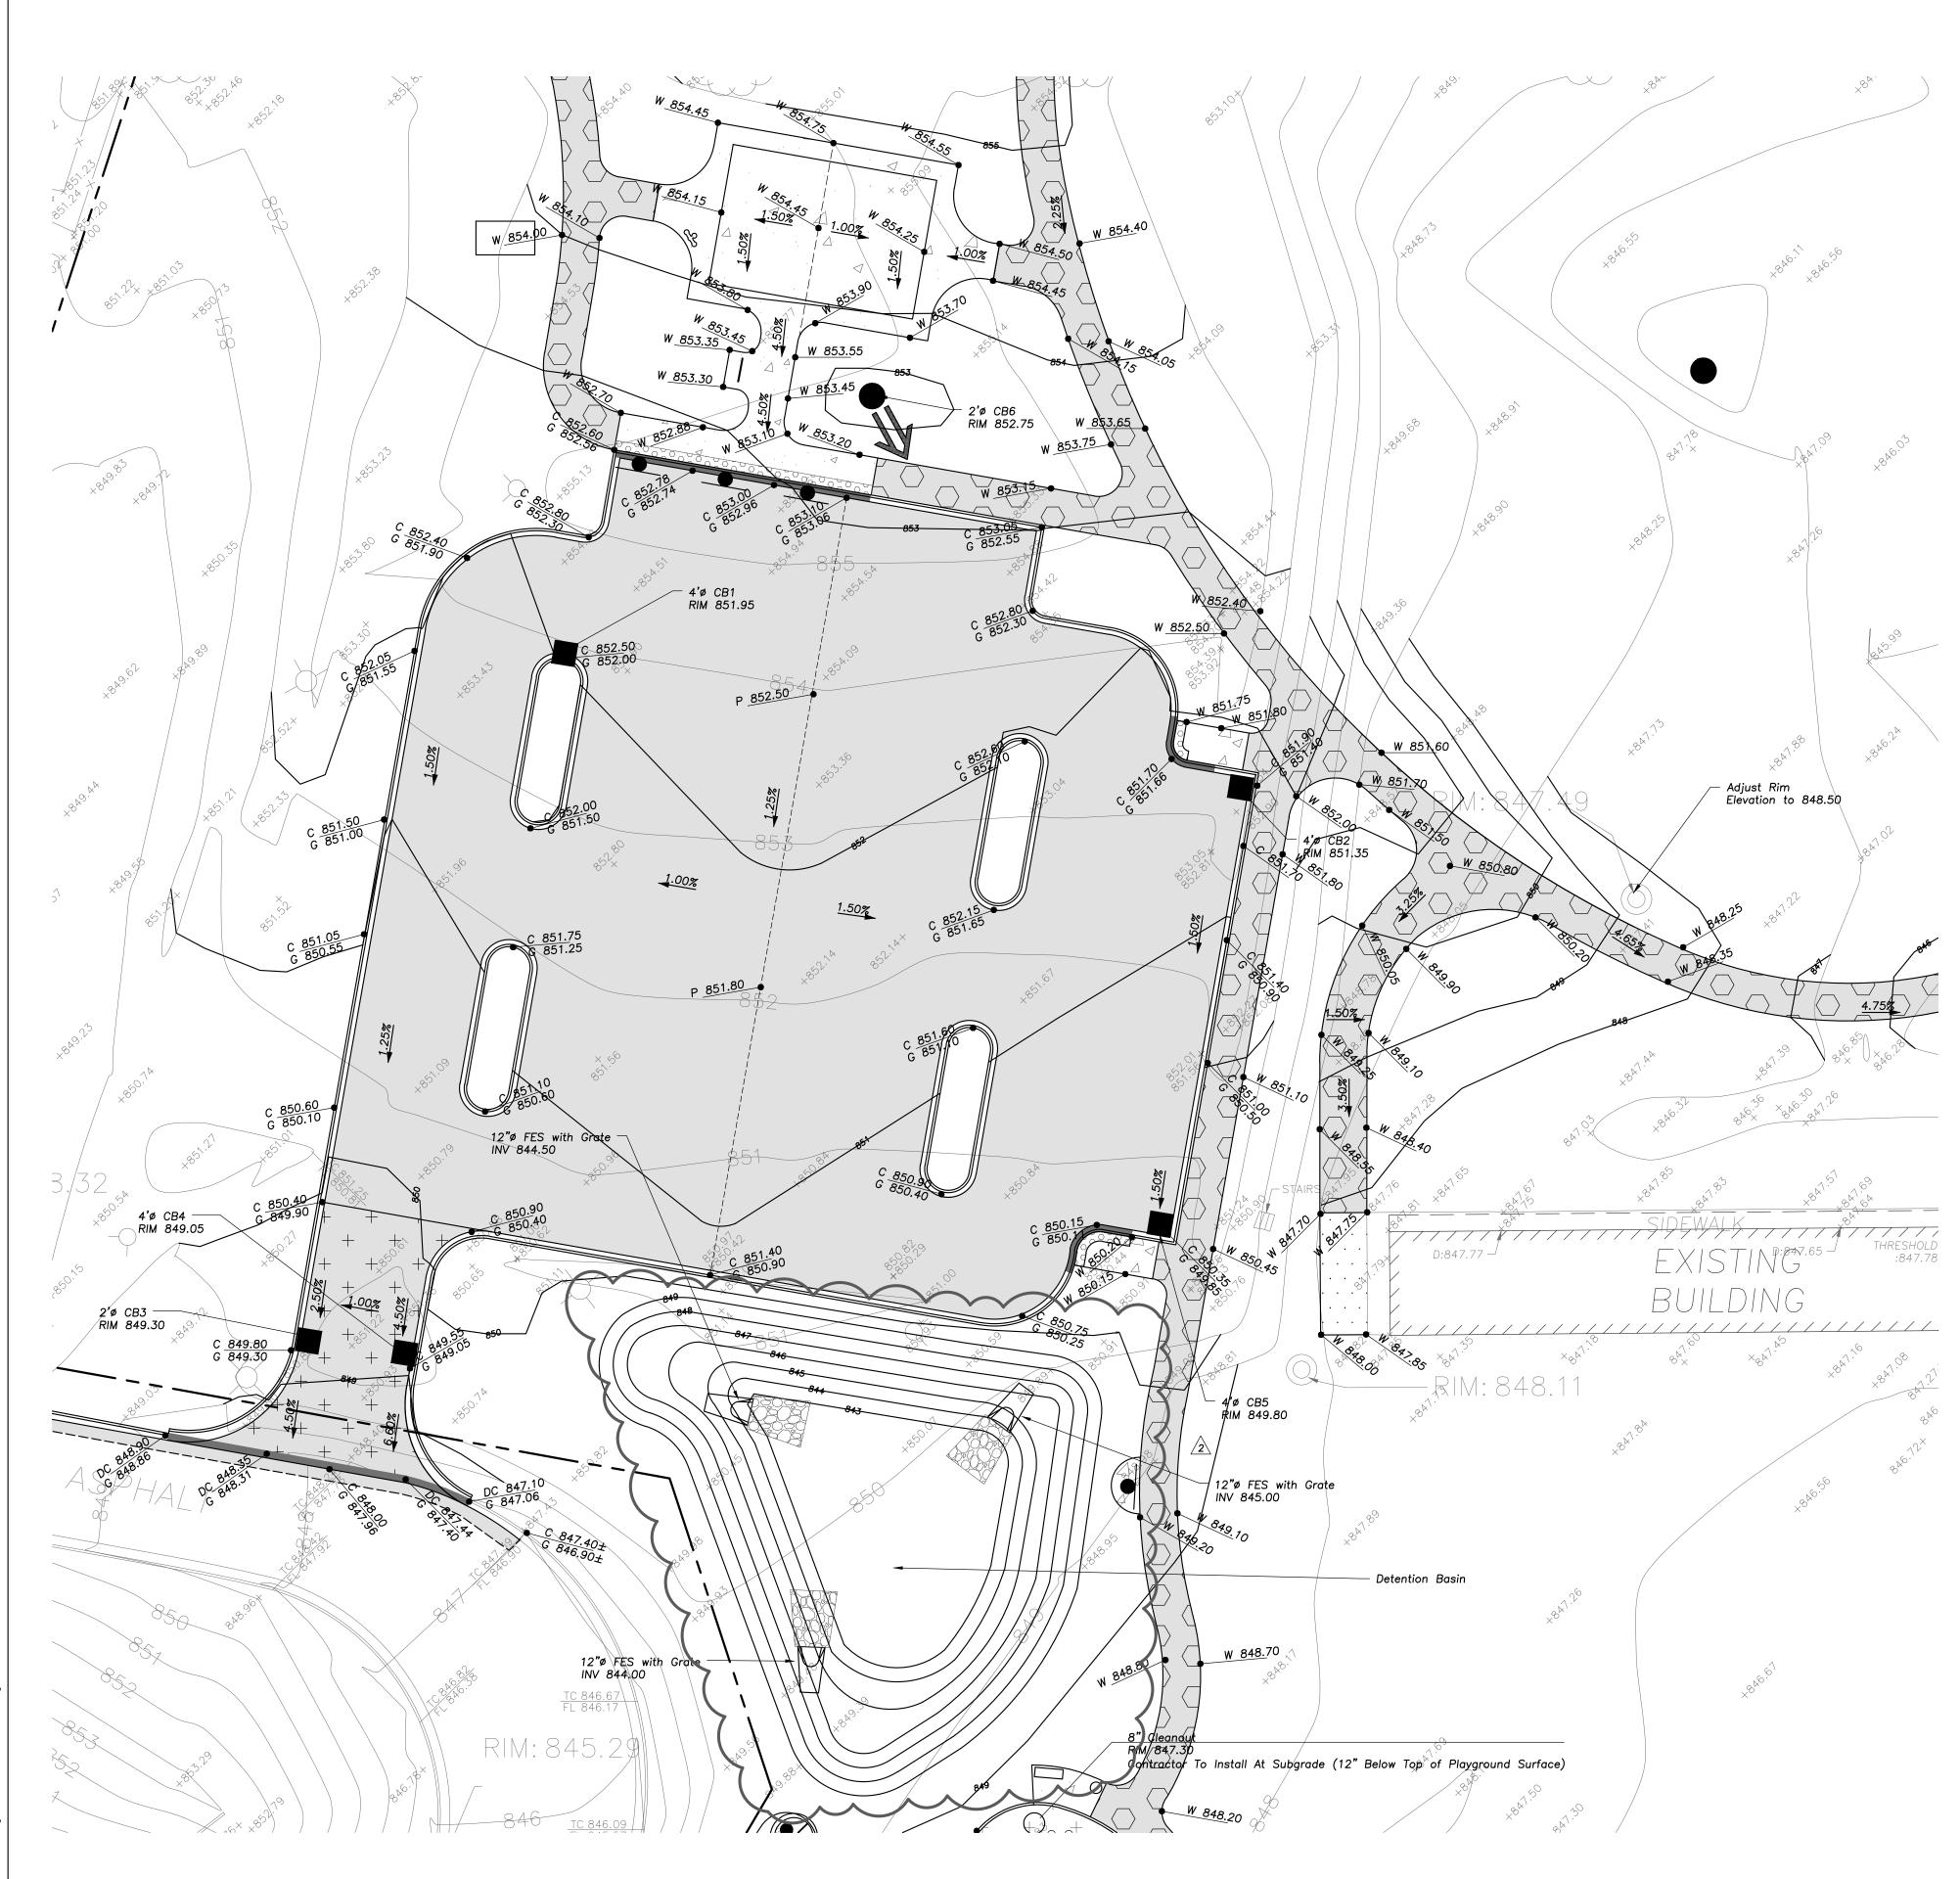



Per the IDNR EcoCAT Review #2409359, the Contractor Shall Follow the IDNR Guidance Listed Below. 1. Educate personnel working on site about the Blanding's Turtle. Post photos of juvenile and adult Blanding's turtles at a central location. 2. Conduct daily inspections during constructions to ensure that exclusionary fencing is properly installed (dug into the ground) and to check if turtles are present. 3. Trenches should be covered at the end of each workday. Before starting each workday, trenches and excavations should be routinely inspected to ensure no turtles (or other amphibians and reptiles) have become trapped within them. 4. If Blanding's turtles are encountered, crews should stop



## GRADI

- Surface of Proposed Improvements.
- Landscape Drawings.
- Sidewalks.
- Longitudinal Sidewalk Slope Shall Be 4.9%. Contact Engineer if Conflicts Exist.
- Match Proposed Ground Elevations.

### PAVING & SURFACE LEGEND

	<b>Asphalt</b> 1 1/2" 2 1/2" Prime ( 8" Aggi Non-Wo
	Concret 5" Port 6"x6" V 2" Aggi
+ +	Heavy– 1 1/2" 3 1/2" Prime ( 10" Agg Non–Wa
	<b>Light</b> —I 3" Hot 6" Agg
+ + + + + + + + + + + + + + + + + + +	<b>Playgro</b> See La Section
	Concre 8"Por 6"x6" 6"Agg

 $\Rightarrow$ 

work immediately, allow the turtle to move out of the way and contact IDNR at (217) 785–5500.

ING NOTES	)

1. The Grading and Construction of Proposed Improvements Shall Be Done In A Manner Which Will Allow For Positive Drainage, and Not Cause Ponding of Stormwater on the

2. All Landscaped Areas Disturbed By Construction Shall Be Respread With 6 Inches (Min.) to 12 Inches (Max.) Topsoil and Hydroseeded Unless Noted Otherwise On The

3. Refer to Architectural Drawings for Locations and Patterns of Expansion and Control Joints in Concrete Pavement and

4. Accessible Parking Spaces and Loading Spaces Shall Be Sloped at Maximum 2.0% in Any Direction. Maximum Sidewalk Cross Slopes Shall be 2.0%. Maximum

5. Rebuild Existing Structures and Adjust Rim Elevations to

Pavement Section Hot Mix Asphalt,Mix D, IL—9.5, N50 Hot Mix Asphalt, IL-19.0, N50 Coat (0.25 gal/sq yd) Igregate Base Course, Type B, Crushed, CA-6 Noven Geotextile Fabric, 5 oz/sy

ete Sidewalk Section rtland Cement Concrete W1.4xW1.4 Welded Wire Fabric gregate Base Course, Type B, Crushed

-Duty Asphalt Pavement Section Hot Mix Asphalt,Mix D, IL-9.5, N50 Hot Mix Asphalt, IL—19.0, N50 Coat (0.25 gal/sq yd) ggregate Base Course, Type B, Crushed, CA–6 Woven Geotextile Fabric, 8 oz

-Duty Asphalt Pavement Section Mix Asphalt,Mix D, IL-9.5, N50

gregate Base Course, Type B, Crushed

round Section andscape Architect's Plans For Details

ete Driveway Section ortland Cement Concrete W2.9xW2.9 Welded Wire Fabric gregate Base Course, Type B, Crushed


Stormwater Overland Flow Path

———— Ridge Line/High Point

0	20	40	6
S	cale: 1"=20'		
C	LEGEND		
EXISTING		PROPOSED	
$\bigcirc$	Manhole	۲	
$\oplus$	Catch Basin	•	
$\square$	Inlet Area Drain		
⊂ ○ <sub>c.o.</sub>	Clean Out	O <sub>c.o.</sub>	
- C.O.	Flared End Section		
)	Storm Sewer	»	
)	Sanitary Sewer		
	Combined Sewer		
W G	Water Main Gas Line	W G	
OH	Overhead Wires	он	
——— E ———	Electrical Cable	——E——	
т	(Buried) Telephone Line	т	
, Q	Fire Hydrant	×.	
$\otimes$	Valve Vault	•	
$\otimes_{B}$	Buffalo Box	€ <sub>B</sub>	
$O_{DS}$	Downspout	O <sub>DS</sub>	
$\bigcirc_{BOL}$	Bollard	$\mathbf{O}_{BOL}$	
$\otimes_{_{G}}$	Gas Valve		
Ø <sub>G</sub>	Gas Meter		
$\mathbb{O}_{E}$	Electric Meter		
O <sub>e</sub>	Electric Manhole		
H	Hand Hole		
X	Light Pole	×	
o——)X	Light Pole w/ Mast Arm		
-0-	Utility Pole	-0-	
	Telephone Pedestal		
© <sub>T</sub>	Telephone Manhole		
Ч	Sign		
Ч хх	Fence	۳ ××	
R	Accessible	L	
GL	Parking Stall	Or	
	Curb & Gutter		
	Depressed Curb Curb Elevation		
× C 782.50 × G 782.00	Gutter Elevation	<u>C 782.50</u> G 782.00	
x P 783.25	Pavement Elevation	<u>P 783.25</u>	
× W 782.10	Sidewalk Elevation	W 782.10	
× 784.0	Ground Elevation	<sub>x</sub> 784.0	
× T/W 785.20	Top of Retaining Wall Elevation		
• • •	Swale	•• •	••
	Contour Line		
M E • 3	Deciduous Tree		
The we	Coniferous Tree		
$\vee$ $\checkmark$	Brushline Troc. Brotestion		
	Tree Protection Fencing at Drip Line	×	
GEN	ERAL NOT	res	

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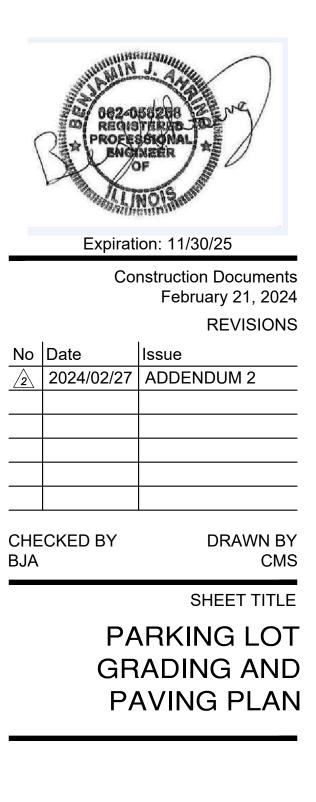
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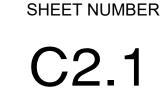
## Meadowlark Park **Final Design** Phase One


1502 W Northwest Highway, Palatine, Illinois, 60067 CONSULTANTS Civil Engineer Eriksson Engineering Associates Grayslake, Illinois 60030 T 847.223.4804

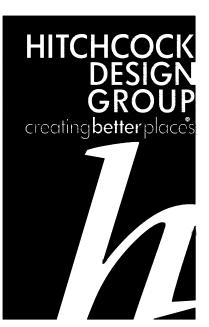
> Electrical Engineer Nova Engineering PC Schererville, Indiana 46375 T 219.865.3352







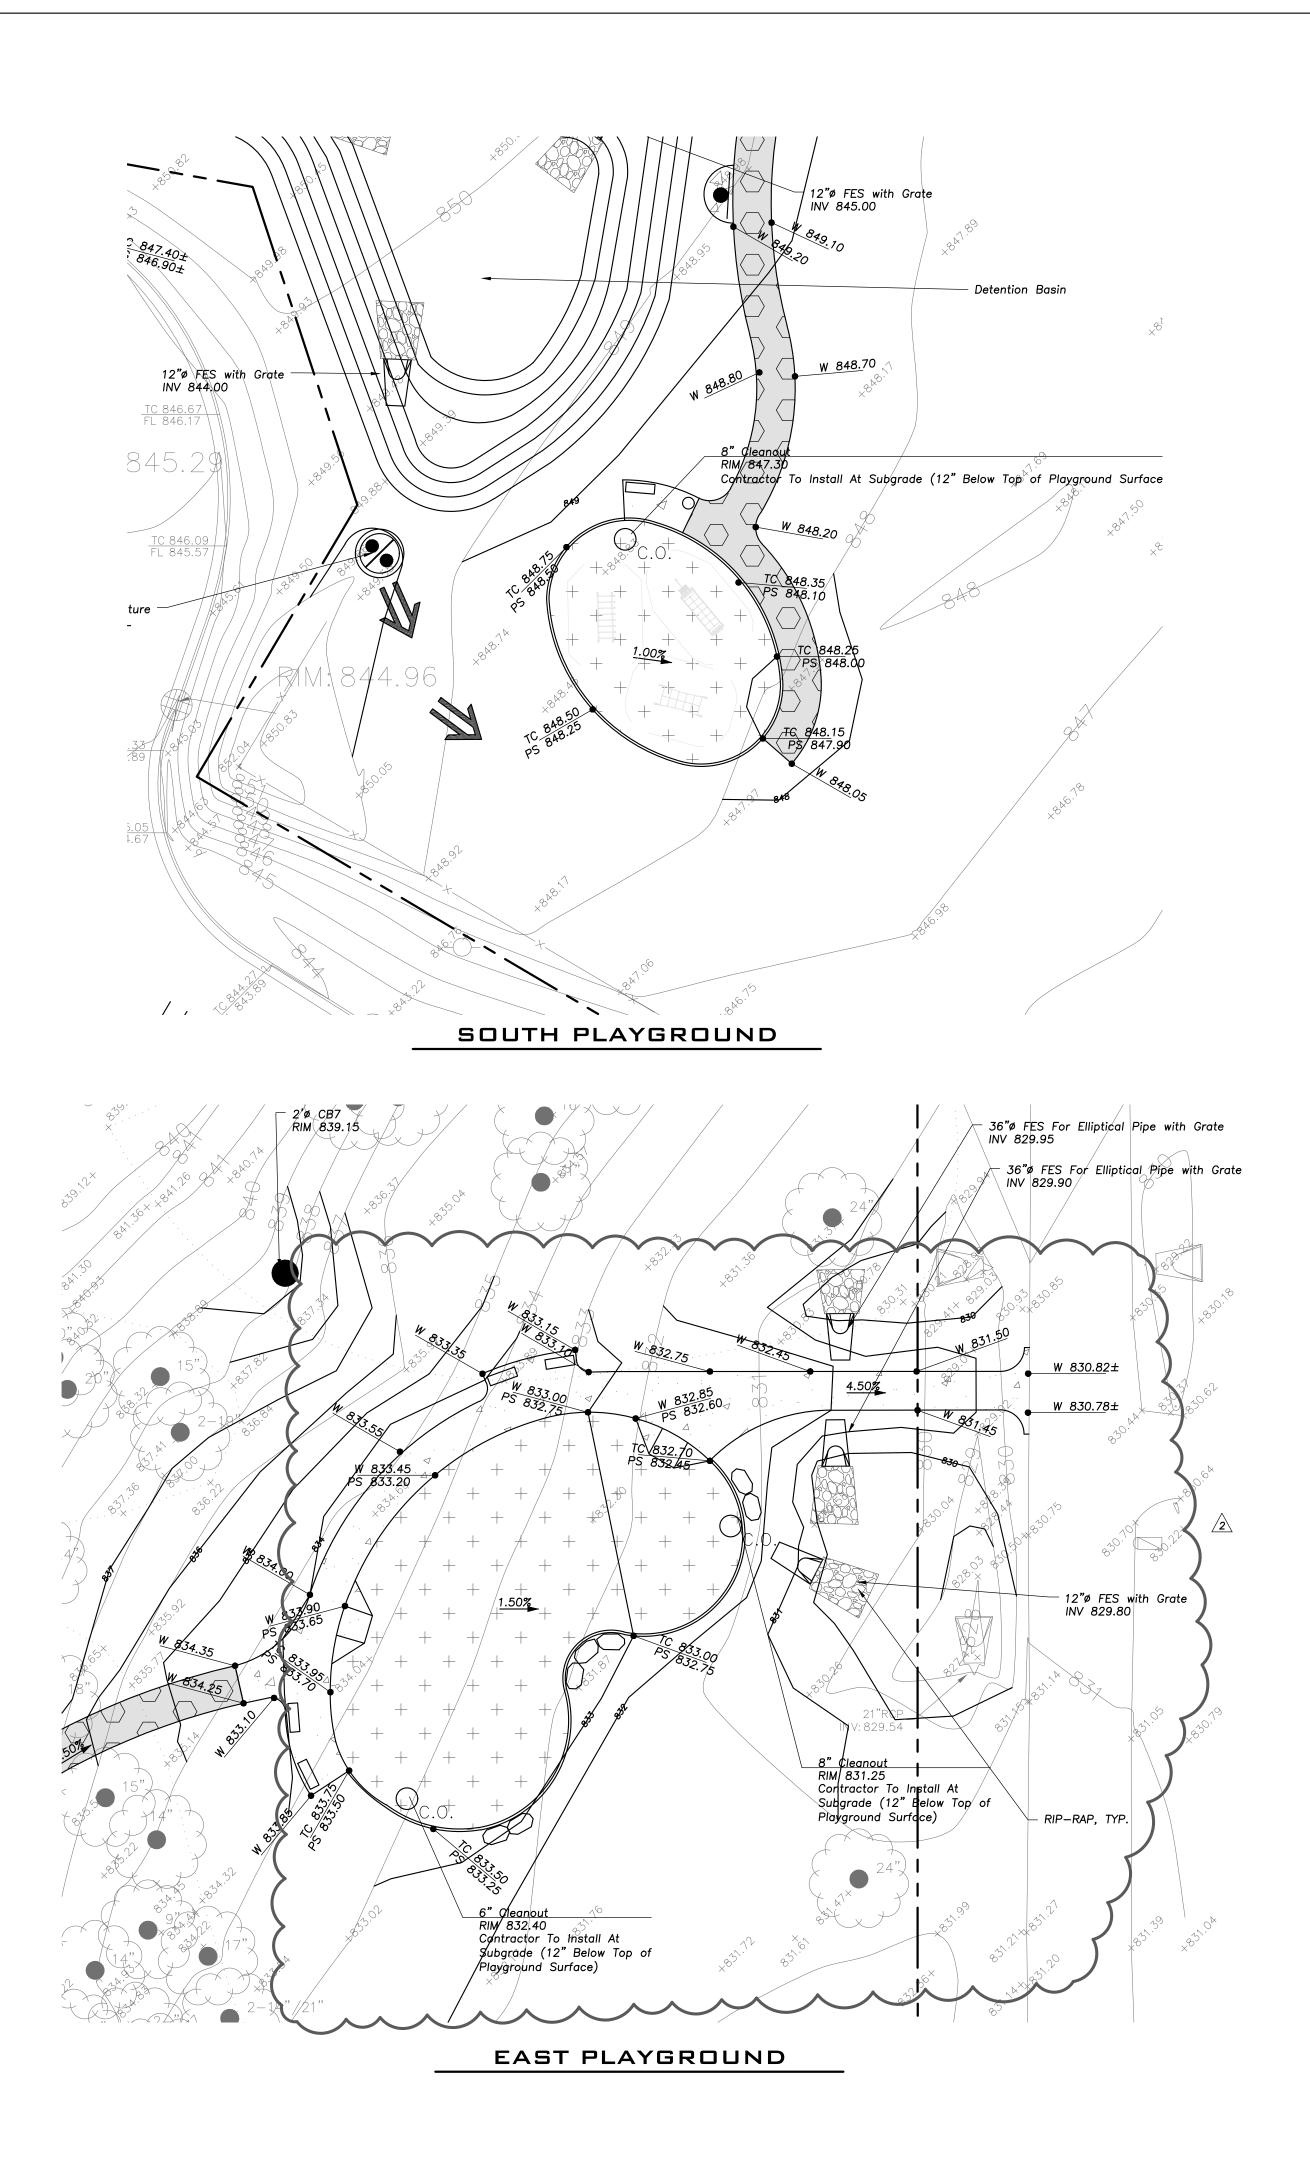

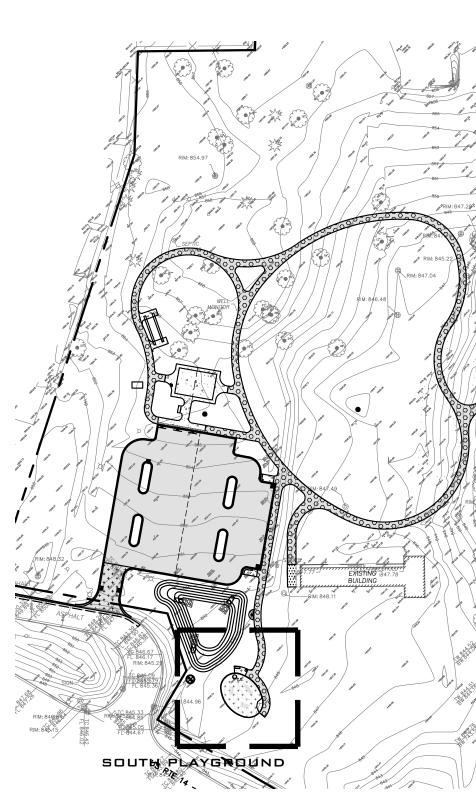

KEY MAP

### GRADING

- 1. The Grading and Construction of Shall Be Done In A Manner Wh Drainage, and Not Cause Pond Surface of Proposed Improvem
- 2. All Landscaped Areas Disturbed Respread With 6 Inches (Min.) and Hydroseeded Unless Noted Landscape Drawings. 3. Refer to Architectural Drawings
- of Expansion and Control Join Sidewalks.
- 4. Accessible Parking Spaces and Loading Spaces Shall Be Sloped at Maximum 2.0% in Any Direction. Maximum Sidewalk Cross Slopes Shall be 2.0%. Maximum Longitudinal Sidewalk Slope Shall Be 4.9%. Contact Engineer if Conflicts Exist. 5. Rebuild Existing Structures and Adjust Rim Elevations to Match Proposed Ground Elevations.

## PAVING & SURFACE LEGEND

<ul> <li>Per the IDNR EcoCAT Review #2409359. the Contractor Shall Follow the IDNR Guidance Listed Below.</li> <li>1. Educate personnel working on site about the Blanding's Turtle. Post photos of juvenile and adult Blanding's turtles at a central location.</li> <li>2. Conduct daily inspections during constructions to ensure that exclusionary fencing is properly installed (dug into the ground) and to check if turtles are present.</li> <li>3. Trenches should be covered at the end of each workday. Before starting each workday, trenches and excavations should be routinely inspected to ensure no turtles (or other amphibians and reptiles) have become trapped within them.</li> <li>4. If Blanding's turtles are encountered, crews should stop work immediately, allow the turtle to move out of the way and contact IDNR at (217) 785-5500.</li> </ul>



	Prime Co 10" Aggr Non–Wov
	Light–D 3" Hot 6" Aggr
+ + + + + + + + + + + + + + + + + + + +	<b>Playgrou</b> See Lan Section
	Concreto 8"Portl 6"x6"W

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		Inlet		
	$\bigtriangleup$	Area Drain		
	O <sub>c.o.</sub>	Clean Out Flared End Section		
	)	Storm Sewer	)	
	)	Sanitary Sewer		
		Combined Sewer		
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a the second sec	OH	Overhead Wires	OH	
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	Sc	Gas Valve		
	∞ <sub>G</sub> M <sub>F</sub>	Gas Meter		
	_	Electric Meter Electric Manhole		
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-	© <sub>T</sub>	Telephone Manhole		
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		Accessible Parking Stall	Ğ.	
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	× C 782.50 × G 782.00	Gutter Elevation	<u>C 782.50</u> G 782.00	
	x P 783.25	Pavement Elevation	<u>P 783.25</u>	
	× W 782.10 × 784.0	Sidewalk Elevation Ground Elevation	<u>W 782.10</u> <sub>x</sub> 784.0	
	× 784.0 × T/W 785.20	Top of Retaining Wall	x 784.0 T/W 785.20	
NOTES	•••	Élevation Swale		
Proposed Improvements		Contour Line	781—	
h Will Allow For Positive g of Stormwater on the	MZ ( )	Deciduous Tree		
ts.		Coniferous Tree Brushline		
By Construction Shall Be 9 12 Inches (Max.) Topsoil Otherwise On The		Brushline Tree Protection Fencing at Drip Line	x	
or Locations and Patterns	GEN	ERAL NO	res	

- Asphalt Pavement Section 1 1/2" Hot Mix Asphalt, Mix D, IL-9.5, N50 2 1/2" Hot Mix Asphalt, IL-19.0, N50 Prime Coat (0.25 gal/sq yd) 8" Aggregate Base Course, Type B, Crushed, CA—6 Non-Woven Geotextile Fabric, 5 oz/sy
- Concrete Sidewalk Section 5" Portland Cement Concrete 6"x6" W1.4xW1.4 Welded Wire Fabric
- 2" Aggregate Base Course, Type B, Crushed Heavy-Duty Asphalt Pavement Section 1/2" Hot Mix Asphalt,Mix D, IL-9.5, N50 5 1/2" Hot Mix Asphalt, IL—19.0, N50
  - Coat (0.25 gal/sq yd) gregate Base Course, Type B, Crushed, CA–6 oven Geotextile Fabric, 8 oz
  - Duty Asphalt Pavement Section Mix Asphalt,Mix D, IL-9.5, N50 regate Base Course, Type B, Crushed
  - und Section ndscape Architect's Plans For Details
- ete Driveway Section tland Cement Concrete 6"x6" W2.9xW2.9 Welded Wire Fabric 6" Aggregate Base Course, Type B, Crushed
- Stormwater Overland Flow Path
- ———— Ridge Line/High Point

- \_\_\_\_\_ Information and Is Given For The Convenience of The Contractor. However, The Owner and The Engineer Do Not Assume Responsibility In The Event That During Construction, Utilities Other Than Those Shown May Be Encountered, and That The Actual Location of Those Which Are Shown May Be Different From The Location As Shown On The Drawings. Contact Engineer Immediately If Surface and/or Subsurface Features Are Different Than Shown On The Drawings.
- 2. Notify The Engineer Without Delay of Any Discrepancies Between the Drawings and Existing Field Conditions.
- 3. Contractor Shall Provide Private Utility Locating Services for the Project Area.
- 4. Notify The Owner, Engineer and The Village of Palatine A Minimum of 48 Hours In Advance of Performing Any Work.
- All Areas, On or Off Site, Disturbed During Construction Operations and Not Part of the Work As Shown Hereon - 5. Shall Be Restored To Original Condition to the Satisfaction of the Owner at No Additional Cost to the Owner. It is Incumbent Upon Contractor to Show That Damaged Areas Were Not Disturbed By Construction Operations.
- 6. These Drawings Assume That The Contractor Will Utilize An Electronic Drawing File (DWG) to Stake All Site Improvements Accordingly. Contractor Shall Re-Establish Horizontal Control. Horizontal Control Points Not Provided.
- 7. No Person May Utilize The Information Contained Within These Drawings Without Written Approval From Eriksson Engineering Associates, Ltd.
- The Engineer Is Furnishing These Drawings For Construction Purposes As A Convenience To The Owner, Architect, Surveyor, or Contractor. Prior To The Use Of These Drawings For Construction Purposes, The User Of This Media Shall Verify All Dimensions And Locations Of Buildings With The Foundation Drawings And Architectural Site Plan, and Coordinate All Dimensions and Locations of All Site Items. If Conflicts Exist The User Of This Information Shall Contact The Engineer Immediately.
- 9. Provide An As-built Survey Prepared By A Licensed Professional Land Surveyor In Accordance With The Authorities Having Jurisdiction Which Shall Include As a Minimum All Detention Basins and Best Management Practices, Include All Storm and Sanitary Sewers, Structure Locations, Sizes, Rim and Invert Elevations, Final Detention Volume Calculations For The Basin(s), Watermain and Valve and Appurtenance Locations.
- 10. The Illinois Department Of Transportation Standard Specifications For Road And Bridge Construction Latest Edition, And All Addenda Thereto, Shall Govern The Earthwork And Paving Work Under This Contract Unless Noted Otherwise.



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# PREPARED FOR Palatine Park District


250 East Wood Street, Palatine, Illinois, 60067

## PROJECT

## Meadowlark Park Final Design Phase One


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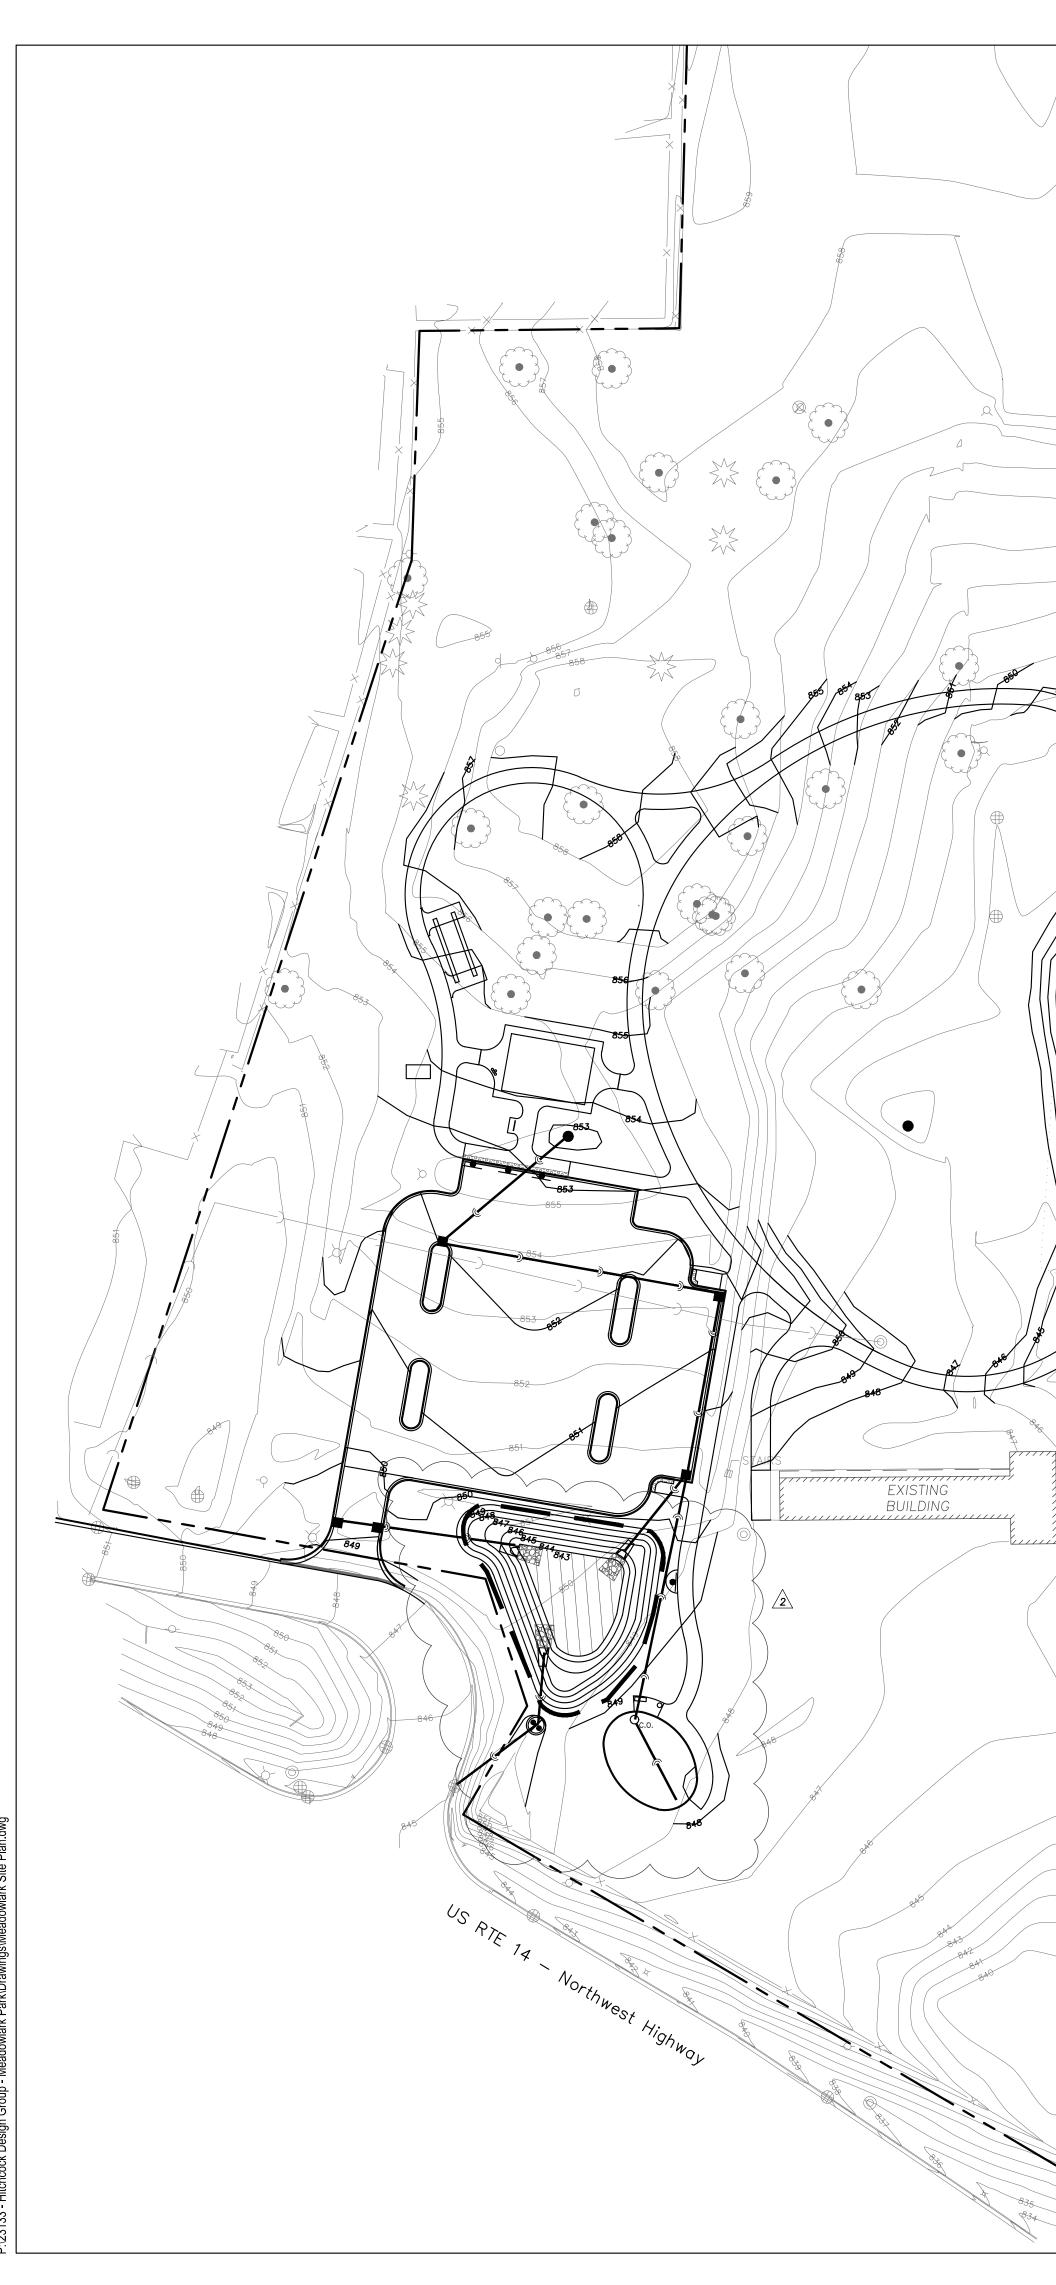
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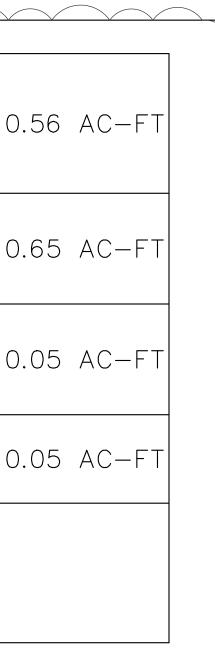




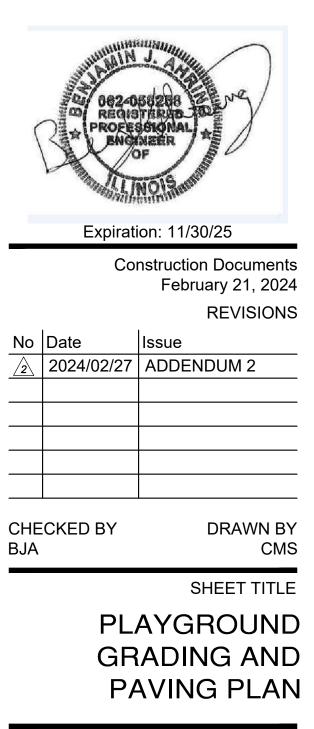



	DETENTION HWL	849.00	DETENTION	REQUIRED	0.
	BOTTOM OF DETENTION	844.00	DETENTION	PROVIDED	0.
857	BOTTOM OF VC FACILITY	843.00	TOTAL VC	REQUIRED	0.
854	SHGWT	841.00	BENEATH	BASIN VC PROVIDED	
853 852 851 850	SEPARATION BETWEEN VC AND SHGWT	2.00			
		Storm Olume Control (Phase 1) Detention Olume (Phase 1 & 2)	PROJ Property Index 02-08-201-0 02-08-201-0 02-08-201-0 02-08-201-0 Property Addred 1502 W. North Total Contiguo 11.77 Acres Development A 0.66 Acres (P 0.52 Acres (P 1.18 Acres (Total Require 0.05 ac 0.56 ac	107 108 1 <del>ss:</del> Iwest Hwy, Palatine, IL 11 11 11 12 12 12 12 12 12 12 12 12 12	SUI

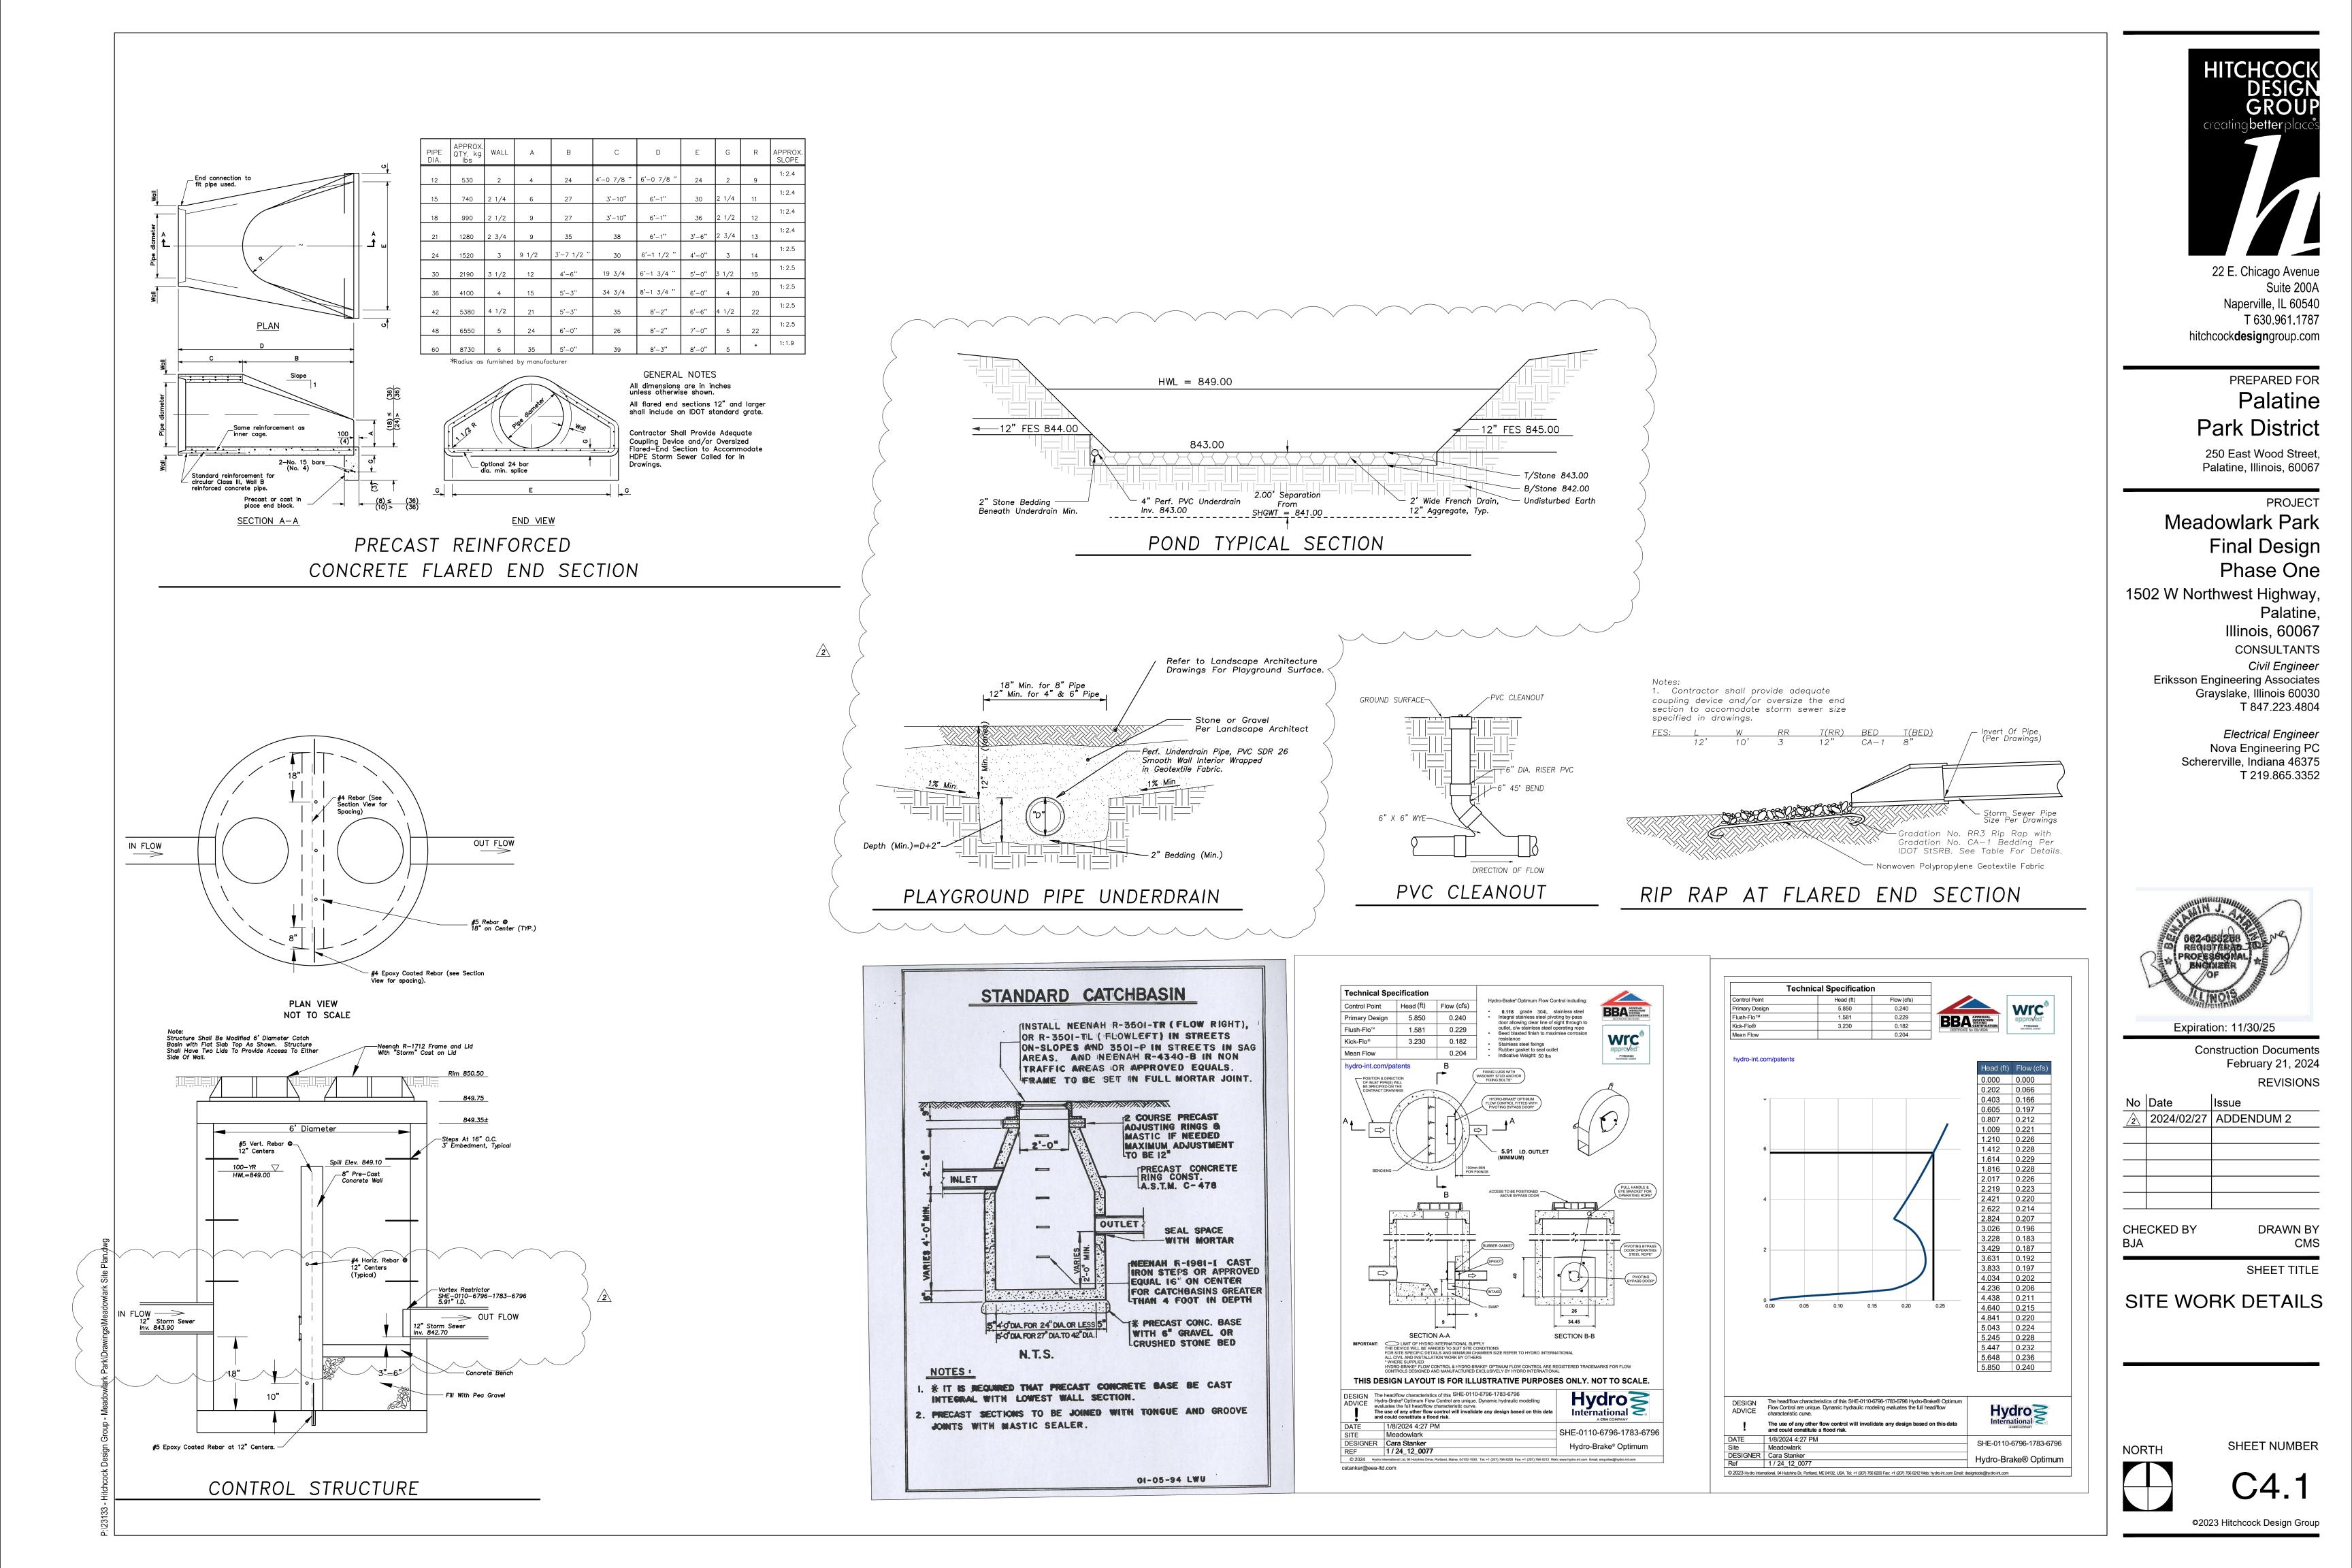


## ONTACT MATION

of Parks and Planning

## UMMARY

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## - Roads Shall Be Swept, Vacuumed And/Or Washed On A Regular Basis
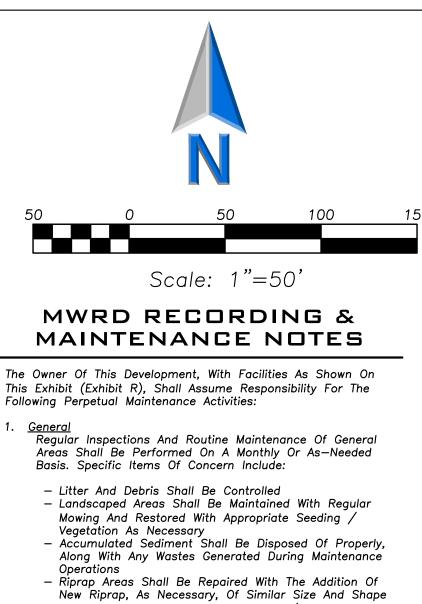
## 2. <u>Stormwater Management Facilities</u> All Components Of The Stormwater Management Facilities Shall Be Checked Monthly Between March And November And Maintained As Necessary To Ensure Proper Performance. It Is Critical That All Inflows And Outflows To The Detention Facility Are Clean And Performing As Designed. In Addition, The Design Volume Of The Detention Facility Shall Also Be Maintained. Inspections For The Following Specific Items Should Be Conducted Monthly Between March And November:

<u>Side Slopes/Embankment/Emergency Overflow Structure</u> – Inspect Embankments For Settlement And Erosion – Remove Woody Growth From The Embankment - Any Breaks, Hire Registered Professional Engineer For

- Design Resolution
- Seed And Sod Any Eroded Areas
- Signs Of Piping (Leakage) Or Seepage, Repair Stabilize Emergency Overflow Structure If Erosion Observed
- Remove Obstructions Blocking Emergency Overflow Spillway
- <u>Outlet Control Structure</u> Inspect Restrictor And Remove Debris If Clogged Or Discharge Reduced - Remove Accumulated Sediment At Outlet
- Scour And Erosion At Outlet, Repair And Ressed
   Any Ice Damage To Outlet Of Pipe, Repair If
- Necessary Condition Of Trash Racks, Remove Debris - Outlet Pipe Conditions Downstream
- Access For Maintenance Equipment - Remove Any Obstructions Placed In Maintenance Easements
- <u>Safety Features</u> — Áccess Controls To Hazardous Areas
- Fences - Loose Or Damaged Posts
- Loose Or Broken Wires - Condition Of Gates
- Signs
- <u>Detention Volume</u> Inspect All Stormwater Detention Facilities To Ensure That The Constructed Volume For Detention Is Constructed Volume For Other Dumping Maintained. No Sediment, Topsoil, Or Other Dumping Into The Facility Shall Be Allowed. Specific Locations In The Stormwater Management System, Design To Accumulate Sediment, Shall Be Dredged As Necessary To Prevent Sediment From Reaching The Invert Of Any Gravity Outlet Pipe.
- <u>Volume Control Facility</u> Routing Inspections And Maintenance Of Volume Control Facilities Shall Be Performed By The Owner On A Yearly Or As-Needed Basis. Specific Items Of Concern Include:
- Facility Shall Be Inspected Yearly Using The Monitoring Well To Verify The System Is Functioning Properly. - Accumulated Sediment From The Surface Shall Be
- Vacuumed Out And Disposed Of Properly. – Appropriate Signage Shall Be Repaired If Damaged Or Illegible.
- <u>Stormwater Collection System</u> The Owner Shall Perform Monthly Inspections Of All Components Of The Stormwater Collection System. The Monthly Inspection Shall Occur Between March And November And Include The Following Specific Areas Of Concern:
- <u>Storm\_Inlets/Manholes</u> Remove Accumulated Leaves And Other Debris From Grates
- Reset Covers/Lids On As-Needed Basis Remove Accumulated Sediment From Manhole Bottom When 50% Of Sump Is Filled
- <u>Storm Sewers/Culverts</u> Visually Inspect Pipes By Removing Manhole Lids, Make Repairs As Necessary
- Storm Sewers And Culverts Shall Be Checked For Siltation Deposits At Inlets, Outlets, And Within The Conduit; Clean Out As Neccesary
- Restore Riprap At Outfalls If Erosion Observed
   Replant And Reseed Any Eroded Areas
- <u>Overland Flow Routes (Ditches/Swales)</u> Annual Visual Inspections Shall Be Performed That Verify The Design Capacity Of The Overland Flow Routes Is Maintained. The Slope And Cross-Sectional Area Of The Ditch/Swale Shall Be Verified During This
- Inspection. Remove Any Obstructions That Have Been Placed In The Drainage Path
   Seed And Sod Any Eroded Areas
- Restore Riprap As Necessary
- Regrade To Provide Positive Drainage As Necessary - Regular Moving To Control Vegetation

LEGEND

— Property Line

- Storm Sewer
- Detention Facility
- Volume Control Facility



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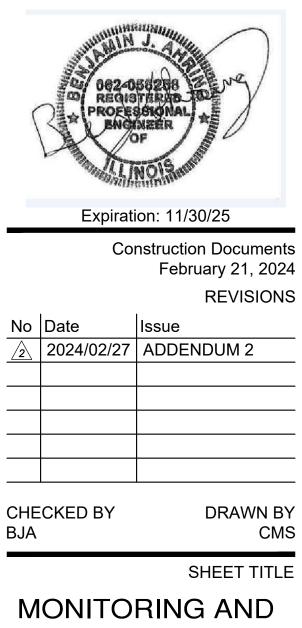
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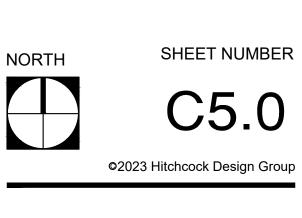
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# MAINTENANCE EXHIBIT



Project Type (From ab Project Category (From Above)	Media File #/Name	Project Category Cost	ADA Portion of Project Cate <sub>l</sub> % AD	
Rec amenities & Rout: Accessible route, Play grounds, adventure p	la 1-7	736702.4	5 235371.48	31.95%
				#VALUE!
				#DIV/0!
Total Project Cost	736702.4	15		
Total ADA Portion of Project Cost	235371.4	8		
Total % of ADA Dollars Requested	31.95	%		